

NOTICE OF PROPOSED DEVELOPMENT

Notice is hereby given that an application has been made for planning approval for the following development:

SITE: 8 Inverness Street, Midway Point

PROPOSED DEVELOPMENT:

DWELLING

The relevant plans and documents can be inspected at the Council Offices at 47 Cole Street, Sorell during normal office hours, or the plans may be viewed on Council's website at www.sorell.tas.gov.au until Monday 28th April 2025.

Any person may make representation in relation to the proposal by letter or electronic mail (<u>sorell.council@sorell.tas.gov.au</u>) addressed to the General Manager. Representations must be received no later than **Monday 28th April 2025**.

APPLICANT: Wilson Homes Tasmania Pty Ltd

APPLICATION NO: DA 2025 / 72 1 DATE: 04 April 2025

Part B: Please note that Part B of this form is publicly exhibited.

Full description of Proposal:	Use:				
or reposum	Development:				
	Large or complex proposals s	hould be described	l in a letter or planning report.		
Design and cons	struction cost of proposal:	\$			
Is all, or some tr	ne work already constructed:	No: □	Yes: □		
Location of					
proposed	Street address:				
works:	Certificate of Title(s) Volum		code:		
	Certificate of Title(3) Volum				
Current Use of					
Site					
Current Owner/s:	Namo(s)				
Is the Property of Register?	Is the Property on the Tasmanian Heritage Register? No: Yes: If yes, please provide written advice from Heritage Tasmania				
Is the proposal to be carried out in more than one stage?		No: ☐ Yes: ☐	If yes, please clearly describe in plans		
Have any potent been undertake	tially contaminating uses n on the site?	No: ☐ Yes: ☐	If yes, please complete the Additional Information for Non-Residential Use		
Is any vegetation	proposed to be removed?	No: ☐ Yes: ☐	If yes, please ensure plans clearly show area to be impacted		
Does the proposal involve land administered or owned by either the Crown or Council? No: Yes: If yes, please complete the Council or Crown land section on page 3					
If a new or upgraded vehicular crossing is required from Council to the front boundary please					
•	chicular Crossing (and Associa cell.tas.gov.au/services/egine		ication form		
110003.77 ** ** ** **	cintasigo via aj sei vicesj egine	<u> </u>	SORELL		

Sorell Council

Development Application: 5.2025.72.1 Development Application - 8 Inverness Street,
Midway Point P1.pdf
Plans Reference:P1
Date Received:20/03/2025

Declarations and acknowledgements

- I/we confirm that the application does not contradict any easement, covenant or restriction specified in the Certificate of Title, Schedule of Easements or Part 5 Agreement for the land.
- I/we consent to Council employees or consultants entering the site and have arranged permission and/or access for Council's representatives to enter the land at any time during normal business hours.
- I/we authorise the provision of a copy of any documents relating to this application to any person for the purposes of assessment or public consultation and have permission of the copyright owner for such copies.
- I/we declare that, in accordance with s52(1) of the Land Use Planning and Approvals Act 1993, that I have notified the owner(s) of the intention to make this application.
- I/we declare that the information in this application is true and correct.

Details of how the Council manages personal information and how you can request access or corrections to it is outlined in Council's Privacy Policy available on the Council website.

- I/we acknowledge that the documentation submitted in support of my application will become a public record held by Council and may be reproduced by Council in both electronic and hard copy format in order to facilitate the assessment process, for display purposes during public exhibition, and to fulfil its statutory obligations. I further acknowledge that following determination of my application, Council will store documentation relating to my application in electronic format only.
- Where the General Manager's consent is also required under s.14 of the *Urban Drainage Act 2013*, by making this application I/we also apply for that consent.

Crown or General Manager Land Owner Consent

If the land that is the subject of this application is owned or administered by either the Crown or Sorell Council, the consent of the relevant Minister or the Council General Manager whichever is applicable, must be included here. This consent should be completed and signed by either the General Manager, the Minister, or a delegate (as specified in s52 (1D-1G) of the *Land Use Planning and Approvals Act 1993*).

Please note:

- If General Manager consent if required, please first complete the General Manager consent application form available on our website www.sorell.tas.gov.au
- If the application involves Crown land you will also need a letter of consent.
- Any consent is for the purposes of making this application only and is not consent to undertaken work or take any other action with respect to the proposed use or development.

I being responsible for the				
administration of land at		Sorell Council		
declare that I have given permiss	Development Application: 5.2025.72.1 - Development Application - 8 Inverness Street, Midway Point P1.pdf Plans Reference:P1 Date Received:20/03/2025			
Signature of General Manager,				
Minister or Delegate:	Signature:	Date:		

DISPERSIVE SOIL ASSESSMENT

8 Inverness Street

Midway Point

May 2024



Development Application: 5.2025.72.1 -Response to Request For Information - 8 Inverness Street Midway Point - P2.pdf Plans Reference: P2 Date received: 31/03/2025







GEO-ENVIRONMENTAL

SOLUTIONS

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Investigation Details

Client: SJM Property Developments (Aus) Pty Ltd

Site Address: 8 Inverness Street, Midway Point

Date of Inspection: 30/04/2024

Proposed Works: New house

Investigation Method: Geoprobe 540UD - Direct Push

Inspected by: C. Cooper

Site Details

Certificate of Title (CT): 184962/90

Title Area: Approx. 1060 m²

Applicable Planning Overlays:

Bushfire-prone areas, Airport obstacle limitation area,

Waterway and Coastal Protection Areas

Slope & Aspect: 5° W facing slope

Vegetation: Grass & Weeds Disturbed

Background Information

Geology Map: MRT

Geological Unit: Triassic Sandstone

Climate: Annual rainfall 400mm

Water Connection: Mains

Sewer Connection: Serviced-Mains

Testing and Classification: AS2870:2011, AS1726:2017 & AS4055:2021



Investigation

A number of bore holes were completed to identify the distribution and variation of the soil materials at the site, bore hole locations are indicated on the site plan. See soil profile conditions presented below. Tests were conducted across the site to obtain bearing capacities of the material at the time of this investigation.

Soil Profile Summary

BH 1 Depth (m)	BH 2 Depth (m)	uscs	Description
0.00-0.20	0.00-0.10	SM	Silty SAND: grey, brown, slightly moist, loose,
0.20-1.00	0.10-1.10	CI	Sandy CLAY: medium plasticity, brown, slightly moist, stiff,
1.00-1.20	1.10-1.40	SC	Clayey SAND: with gravels, pale yellow, slightly moist dense, refusal.

Site Notes

Soils on the site are developing from Triassic Sandstone. The clay fraction is likely to show moderate ground surface movement.

Dispersive Soil Assessment

The dispersive soil assessment of the property considers the proposed construction area.

Potential for dispersive soils

The site has been identified as an area subject to a tunnel erosion hazard according to 'Dispersive Soils and Their Management: Technical Reference Manual'. This is due to the soils present on site that developed from Triassic Sandstone that contain considerable fine sand/silt content and medium plastic clays. Triassic Sandstone in the local area is known to produce soils with an excess of sodium on the soil exchange complex, which can cause soil dispersion. Under some circumstances the presence of dispersive soils can also lead to significant erosion, and in particular tunnel erosion. Based upon field survey of the property, no visible tunnel or gully erosion was identified. However, a soil sampling program was undertaken to identify the presence of dispersive soils in the proposed development areas.

Soil sampling and testing

Samples were taken at the site for assessment of dispersion. An Emerson (1968) Dispersion test was



conducted to determine if these samples were dispersive.

The soil samples taken from site were found to be Slightly dispersive (Class 2.1) - Some dispersion (slight milkiness, immediately adjacent to aggregate).

Management Recommendations

A number of site and soil management measures are recommended for development on the site.

The proposed site cut/fill and driveway areas must be managed by:

- Applying a geo-fabric, jute mesh or similar material to the exposed batters of any cutting on site and revegetating the slope
- Applying a surface layer of at least 50mm of suitable crushed rock/gravel to the driveway surface (and any proposed house pad), with adequate compaction to ensure a relatively impervious surface to maintain site surface stability
- Vegetation on any fill batters must be established and maintained, if any bare area of soil on the
 batter develops then it must be top-dressed with suitable topsoil and additional vegetation planted

The risk or erosion and tunnel erosion associated with construction must be minimized by:

- Any new water, power, or other service trenches within the property must ensure recommendations for dispersive soils are followed:
- o Where possible trenches to be placed shallow in topsoil and mounded over to achieve the required cover depth
- o If buried the trench must be backfilled in layers of no more than 200mm with clay with 5% by weight gypsum added (the clay must be sufficiently moist to allow good compaction).
- o The trench must be finished with at least 150mm depth of non-dispersive suitable topsoil and finished to a level at least 75mm above natural ground to allow for possible settlement
- Vegetation cover must be maintained wherever possible on the property
- Foundations may be placed into the natural soil; however, care must be taken to ensure all exposed soil in the foundation area is compacted and 1Kg/m2 of gypsum is applied. Excavated fill from the construction area is not recommended for reuse on site in landscaping unless it is appropriately treated with gypsum, compacted, and capped with topsoil with natural soil and gypsum



- All stormwater runoff from the dwelling to be directed to mains connection (all the drains are to be adequately treated with gypsum)
- Drainage of any site cut must not employ conventional rock drain construction; it must adhere to recommendations for dispersive soils (unless founded entirely in rock)
- All excavation works on site should be monitored for signs of soil dispersion and remedial action taken as required any excavated fill from the construction area is not recommended for reuse on site in landscaping unless it is appropriately treated with gypsum, compacted, and capped with topsoil

Conclusions

There is a low risk associated with dispersive soils and potential erosion on the site provided the recommendations in this report are adhered to. Efforts should be made to cover all exposed soils on cut/fill batters with topsoil and seeded with well suited pasture species to avoid rainwater, runoff, surface water flows from intercepting exposed subsoils.

A number of site management recommendations have been made in this report and further information can also be found in the publication "Dispersive soils and their management – Technical manual" (DPIWE Tas 2009)

It is recommended that during construction that GES be notified of any variation to the soil conditions as outlined in this report.

Dr John Paul Cumming B.Agr.Sc (hons) PhD CPSS GAICD

Environmental and Engineering Soil Scientist



Appendix 1-Soil test results

Laboratory Test Results

Sample Submitted By: A Plummer

Date Submitted: 6/05/2024.

Sample Identification: 8 Inverness Street, Midway Point

Soil to be tested: Emerson soil dispersion test.

Result:

Sample	Texture	Emerson class	Description
Sample	Clay	Class 2.(1)	Slight dispersion
Sample	Clay	Class 2.(1)	Slight dispersion

Some dispersion (slight milkiness, immediately adjacent to aggregate).

Sample Tested by: JP. Cumming

6/05/2024



Disclaimer

This Report has been prepared in accordance with the scope of services between Geo-Environmental Solutions Pty. Ltd. (GES) and the Client. To the best of GES's knowledge, the information presented herein represents the client's requirements at the time of printing of the Report. However, the passage of time, manifestation of latent conditions or impacts of future events may result in findings differing from that discussed in this Report. In preparing this Report, GES has relied upon data, surveys, analyses, designs, plans and other information provided by the Client and other individuals and organizations referenced herein. Except as otherwise stated in this Report, GES has not verified the accuracy or completeness of such data, surveys, analyses, designs, plans and other information.

The scope of this study does not allow for the review of every possible geotechnical parameter or the soil conditions over the whole area of the site. Soil and rock samples collected from the investigation area are assumed to be representative of the areas from where they were collected and not indicative of the entire site. The conclusions discussed within this report are based on observations and/or testing at these investigation points.

This report does not purport to provide legal advice. Readers of the report should engage professional legal practitioners for this purpose as required.

No responsibility is accepted for the use of any part of this report in any other context or for any other purpose by third a party.

TASMANIAN PLANNING SCHEME

SHE	ET INDEX
1	COVER SHEET
2	SITE PLAN (1:500)
3	SITE PLAN (1:200)
4	SOIL & WATER MANAGEMENT PLAN
5	GROUND FLOOR PLAN
6	SECTION
7	ELEVATIONS
8	ELEVATIONS
9	WINDOW & DOOR SCHEDULES
10	DRAINAGE PLAN
11	ROOF DRAINAGE PLAN
12	FLOOR COVERINGS
13	KITCHEN DETAILS
14	BUTLER'S PANTRY DETAILS
15	BATHROOM DETAILS
16	ENSUITE DETAILS
17	LAUNDRY DETAILS

TOTAL FLOOR AREAS

MAIN DWELLING, GROUND FLOOR		
	ALFRESCO	10.17
	GARAGE	38.41
	LIVING	181.82
	PATIO	20.40
	PORCH	10.84
		261.64 m

AS & NCC COMPLIANCE

ALL CONSTRUCTION TO BE IN ACCORDANCE WITH NCC 2022 AND APPLICABLE AUSTRALIAN STANDARDS AT TIME OF APPROVAL

- SLAB IN ACCORDANCE WITH AS 2870. REFER TO ENGINEERS DETAILS FOR ALL SLAB DETAILS. BRICK CONTROL JOINTS PROVIDED IN ACCORDANCE WITH NCC 2022.
- ALL STEEL FRAMING TO BE DESIGNED TO AS 4100-2020 OR AS/NZS
- INSULATION TO BE INSTALLED IN ACCORDANCE WITH NCC 2022 AND ALL APPLICABLE AUSTRALIAN STANDARDS.
- TERMITE PROTECTION IN ACCORDANCE WITH AS 3660 AND NCC 2022. GLAZING IN ACCORDANCE WITH AS 1288 AND NCC 2022.
- SMOKE ALARMS IN ACCORDANCE WITH AS 3786 AND NCC 2022. INTERNAL WATERPROOFING IN ACCORDANCE WITH NCC 2022 HOUSING PROVISIONS PART 10.2.
- EXTERNAL WATERPROOFING IN ACCORDANCE WITH AS 3740 AND AS
- WET AREA FLOORS TO FALL TO FLOOR WASTES AT MIN. 1:80 AND MAX 1:50 GRADE (IF APPLICABLE). CONDENSATION MANAGEMENT IN ACCORDANCE WITH NCC 2019.
- BUILDING SEALING IN ACCORDANCE WITH NCC 2022. SERVICES IN ACCORDANCE WITH NCC 2022.

SITE SPECIFIC CONTROLS


- EARTHWORKS IN ACCORDANCE WITH AS 3798-2007. EXTERNAL WALL WRAP (SARKING) IN ACCORDANCE WITH NCC 2022 (IF

EXHAUST FANS DUCTED TO C	OUTSIDE AIR (IF APPLICABLE).

CONTROL	DETAILS
ACID SULPHATE SOIL	NO
BIODIVERSITY	NO
BUILDING ENVELOPE	NO
BUSHFIRE	BAL-12.5
CLIMATE ZONE (NCC)	ZONE 7 - COOL TEMPERATE
DESIGN WIND CLASSIFICATION	N3 (EXPOSED TBC)
ESTATE/DEVELOPER GUIDELINES	NO
FLOOD OVERLAY	NO
HERITAGE	NO
LANDSLIP HAZARD	NO
MINIMUM FLOOR LEVEL	NO
NATURAL ASSET CODE	YES
NOISE ATTENUATION	NO
SALINE SOIL	NO
SHIELDING FACTOR	NS - NO SHIELDING
SITE CLASSIFICATION	M
SPECIFIC AREA PLAN OVERLAY	YES
DISPERSIVE SOILS	
TERRAIN CATEGORY	TC1
TOPOGRAPHIC CLASSIFICATION	T1
WATERWAY & COASTAL OVERLAY	YES
WIND REGION	A - NORMAL
WITHIN 1km CALM SALT WATER	95m
WITHIN 50km BREAKING SURF	6.25km
ZONING	GENERAL RESIDENTIAL
PRIORITY VEGETATION	
AIRPORT OBSTACLE LIMITATION	


BUILDING CONTROLS & COMPLIANCE			
CONTROL	REQUIRED	PROPOSED	
SETBACKS			
FRONT	MIN. 4,500mm	4,500mm	
GARAGE TO BOUNDARY	MIN. 5,500mm	7,253mm	
SIDE A	MIN. 1,500mm	6,552mm	
SIDE B	MIN. 1,500mm	5,980mm	
REAR	MIN. 1,500mm	11,055mm	
BULK & SCALE			
SITE AREA	1,049m²		
SITE COVERAGE	MAX. 50%	24.94%	
LANDSCAPE			
NO APPLICABLE CONTROLS			
EARTHWORKS			
CUT DEPTH	MAX. 2,000mm	1,147mm	
FILL DEPTH	MAX. 1,000mm	979mm	
ACCESS & AMENITY			
PARKING SPACES	MIN. 2 SPACES	2 SPACES	

3D PERSPECTIVE

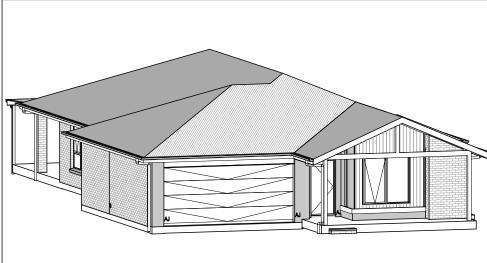

NOTE TO OWNER

THESE PLANS MAY FEATURE WORKS THAT ARE EXCLUDED FROM THE SCOPE OF WORKS WITH THE BUILDER. BUT THEY HAVE BEEN INCLUDED IN THESE DRAWINGS TO ASSIST IN THE OVERALL PLANNING AND ASSESSMENT OF THE BUILDING PROJECT. EXAMPLES OF SOME REGULARLY EXCLUDED WORKS INCLUDE DRIVEWAYS, RETAINING WALLS, SOLAR PANEL SPACING AND SITE DRAINAGE, PLEASE REFER TO YOUR SCOPE OF WORKS AND COLOUR SELECTIONS DOCUMENTATION FOR DETAILS OF INCLUDED WORKS. SOME DETAILS ARE INDICATIVE ONLY FOR EXAMPLE FLOORING, TILING, BRICKWORK AND CLADDING (EXPANSION JOINTS, ORIENTATION AND LAYOUT) AND ARE SUBJECT TO CHANGE.

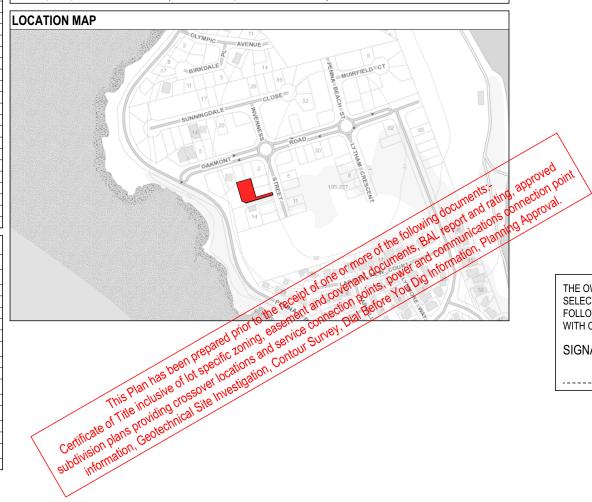

BUILDING INFORMATION GROUND FLOOR TOP OF WALL HEIGHT(S) 2595mm NOTE: CEILING HEIGHT 45mm LOWER THAN TOP OF WALL ROOF PITCH (U.N.O.) 23.0° SINGLE PHASE ELECTRICITY SUPPLY GAS SUPPLY NONE ROOF MATERIAL SHEET METAL ROOF COLOUR WALL MATERIAL BRICK VENEER

CLADDING

INSIII ATION

SLAB CLASSIFICATION

	INSULAI	INSULATION		
	ROOF	MIN. 60mm FOIL FACED BLANKET UNDER ROOFING		
	CEILING R4.1 BATTS (EXCL. GARAGE, ALFRESCO)			
EXT. WALLS R2.0 BATTS (EXCL. GARAGE)				
		WALL WRAP TO ENTIRE HOUSE		
	INT. WALLS	R2.0 BATTS ADJACENT TO GARAGE AND AS PER PLAN		
	FLOOR	BIAY SLAB RO 60		

BUSHFIRE REQUIREMENTS - BAL-12.5

THE BUILDER USES MATERIALS THAT COMPLY WITH AS 3959-2018 OR HAVE BEEN TESTED TO AS 1530.8.1 IN ACCORDANCE WITH AS 3959-2018

- PROVIDE FOIL FACED BLANKET INSULATION TO ALL COLORBOND SHEET ROOFING.
- PROVIDE SARKING TO ALL TILED ROOFING INCLUDING PRESSTITE TO VALLEYS.
- PROVIDE BAL-12.5 RATED DEKTITE TO ALL AIR VENTS ON ROOF. PROVIDE BAL-12.5 RATED ALUMINIUM MESH TO ALL SOFFIT AND EAVE
- PROVIDE BAL-12.5 RATED ALUMINIUM MESH TO ALL EXHAUST VENTS.

VALLS, POSTS AND BEAMS:

PROVIDE SPARK ARRESTORS TO ALL EXTERNAL BRICKWORK. EXTERNAL TIMBER POSTS WITHIN 400mm OF ADJACENT FINISHED FLOOR LEVEL TO BE BUSHFIRE-RESISTING TIMBER UNLESS MOUNTED ON STIRRUPS TO PROVIDE MIN. 75mm CLEARANCE ABOVE ADJACENT FINISHED FLOOR LEVEL.

- WINDOWS AND DOORS:
 PROVIDE FLYSCREENS WITH CORROSION RESISTANT MESH TO ALL OPERABLE WINDOW SASHES (NO REQUIREMENT TO SCREEN BI-FOLD FRENCH / SLIDING / STACKER DOORS).
- PROVIDE BAL-12.5 RATED ALUMINIUM WINDOWS AND EXTERNAL GLASS SLIDING / STACKER DOORS.
- SPECIFIED ALUMINIUM FRENCH DOORS HAVE BEEN TESTED TO AS 1530.8.1 WITHOUT SCREENS.
- SPECIFIED ALUMINIUM WINDOWS HAVE BEEN TESTED TO AS 1530.8.1 WITHOUT SCREENS TO FIXED PANELS.
- PROVIDE ALUMINIUM DOOR JAMBS TO ALL EXTERNAL TIMBER DOORS.
 PROVIDE SAFETY SCREENS WITH CORROSION RESISTANT MESH TO
- EXTERNAL TIMBER HUNG DOORS (IF REQUIRED) PROVIDE SEAL TO ALL GARAGE PANELIFT / ROLLER DOORS.

PROVIDE COPPER WATER PIPES FROM WATER TANK TO HOUSE.



Sorell Council

velopment Application - 8 Inverness Street, lidway Point P1.pdf Plans Reference:P1

Date Received: 20/03/2025

THE OWNERS ACKNOWLEDGE THAT THESE CONTRACT PLANS MAY NOT REFLECT ALL THE SELECTIONS THAT HAVE BEEN MADE OR CHANGES REQUESTED. THE OWNERS AGREE THAT FOLLOWING THE COLOUR SELECTIONS VARIATION OR UPDATING OF PLANS, THEY WILL BE PROVIDED WITH CONSTRUCTION PLANS FOR SIGNATURE PRIOR TO COMMENCEMENT OF CONSTRUCTION.

1 / 17 | 1:100

SIGNATURE:

COVER SHEET

DATE:

SUBJECT TO NCC 2022 (1 MAY 2023)

WATERPROOFING & PLUMBING

PLAN ACCEPTANCE BY OWNER SIGNATURE: DATE: SIGNATURE: DATE:

PLEASE NOTE THAT VARIATIONS WILL NOT BE ACCEPTED AFTER THIS PLAN ACCEPTANCE HAS BEEN SIGNED

> DO NOT SCALE DRAWINGS, USE FIGURED DIMENSIONS ONLY, CHEC AND VERIFY DIMENSIONS AND I EVELS PRIOR TO THE COMMENCEMENT OF ANY WORK. AL DISCREPANCIES TO BE REPORTED TO THE DRAFTING OFFICE.

714196

PRELIMINARY PLAN SET

PRELIMINARY PLAN SET - INITIAL ISSUE

AMENDMENT

No.

			IN AINT WAT KEFF
	SPECIFICATION:		
	DESIGNER	1	QUOTE SITING PLAN
	COPYRIGHT:	2	DRAFT SALES PLAN
	© 2025	3	DRAFT SALES PLAN

	ALL	2025.03.11	TNG	HMI	
	SHEET	DATE	DRAWN	CHECK	
© 2025 WILSON HOMES PTY LTD (ABN 96 126 636 897).	. THIS DRAV	ING IS AN ORI	GINAL ARTIS	TIC WORK \	NITH

HIN THE MEANING OF THE COPYRIGHT ACT 1968 (CTH). WILSON HOMES PTY LTD IS THE OWNER OF COPYRIGHT IN THIS DRAWING. YOU HEREBY AGREE AND UNDERTAKE THAT YOU WILL NOT

90 / - / 184962

	IN ANY WAY DEDDOOD OF CODY MODIEV HOE OF TAKE	ADVANITA OF OF THE	E DRAWING TO BUILD A LIQUIDE BACED ON THIS DLAN WHIETHER INVALIGHE OR IN BARTY WITHOUT THE BRICK WRITTEN O	CALCELIT OF MILLOUIS DTV LTD	
	IN ANY WAY REPRODUCE, COPY, MODIFY, USE OR TAKE	ADVANTAGE OF THE	E DRAWING TO BUILD A HOUSE BASED ON THIS PLAN (WHETHER IN WHOLE OR IN PART) WITHOUT THE PRIOR WRITTEN C	ONSENT OF WILSON HOMES PTY LTD.	-
ECIFICATION:	REVISION	DRAWN	CLIENT:	HOUSE DESIGN:	HOUSE CODE:
ESIGNER	1 QUOTE SITING PLAN	JOL 26/11/2024	ADINE & SHANE BOWERMAN	GORDON 23	H-WDNGDN20SA
PYRIGHT:	2 DRAFT SALES PLAN - CT-1	RT2 16/01/2025	ADDRESS:	FACADE DESIGN:	FACADE CODE:
2025	3 DRAFT SALES PLAN- CT-2	RT2 12/02/2025	8 INVERNESS STREET, MIDWAY POINT TAS 7171	NORSK	F-WDNGDN20NRSKA
	4 PRELIMPLAN - INITIAL ISSUE	TNG 11/03/2025	LOT / SECTION / CT: COUNCIL:	SHEET TITLE: SHEET No.:	SCALES:

SORELL COUNCIL

SUSTAINABILITY REQUIREMENTS SITE CLASSIFICATION GENERAL BUILDING INFORMATION


APPROX. CUT/FILL

142 TONNES OF EXPORT FILL				
DIFFERENCE	63.24m³	142.29t		
FILL	93.95m³	211.39t		
CUT	157.19m³	353.68t		


LOT SIZE: 1049m² HOUSE (COVERED AREA): 261.64m² SITE COVERAGE: 24.94%

Site Datum ORM Rivet in kerb @ RL 30.55

INVERNESS STREET

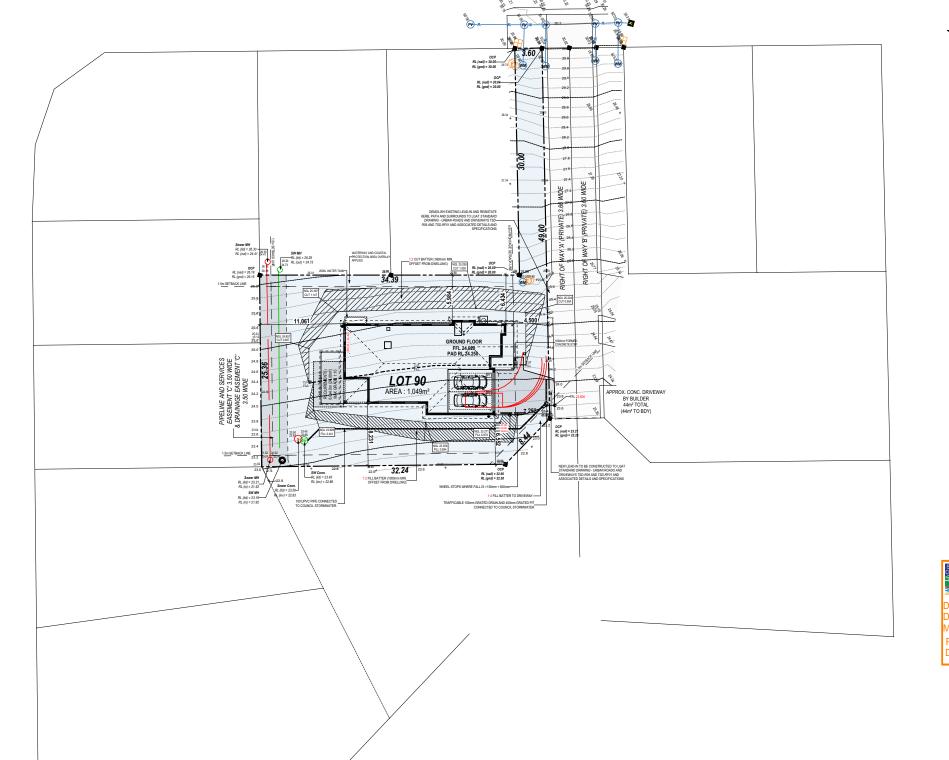

BAL-12.5 BUSHFIRE REQUIREMENTS SEE SHEET 1 (COVER SHEET) FOR DETAILS

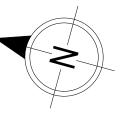

SIGNATURE:

Sorell Council

Development Application: 5.2025.72.1 - Development Application - 8 Inverness Street, Midway Point P1.pdf Plans Reference:P1 Date Received:20/03/2025

> **SUBJECT TO NCC 2022** (1 MAY 2023)

WATERPROOFING & PLUMBING

PLAN ACCEPTAN	NCE BY OWNER
SIGNATURE:	DATE:

PLEASE NOTE THAT VARIATIONS WILL NOT BE ACCEPTED AFTER THIS PLAN ACCEPTANCE HAS BEEN SIGNED

© 2025 WILSON HOMES PTY LTD (ABN 96 126 636 897). THIS DRAWING IS AN ORIGINAL ARTISTIC WORK WITHIN THE MEANING OF THE COPYRIGHT ACT 1968 (CTH). WILSON HOMES PTY LTD IS THE OWNER OF COPYRIGHT IN THIS DRAWING. YOU HEREBY AGREE AND UNDERTAKE THAT YOU WILL NOT IN ANY WAY REPRODUCE, COPY, MODIFY, USE OR TAKE ADVANTAGE OF THE DRAWING TO BUILD A HOUSE BASED ON THIS PLAN (WHETHER IN WHOLE OR IN PART) WITHOUT THE PRIOR WRITTEN CONSENT OF WILSON HOMES PTY LTD.

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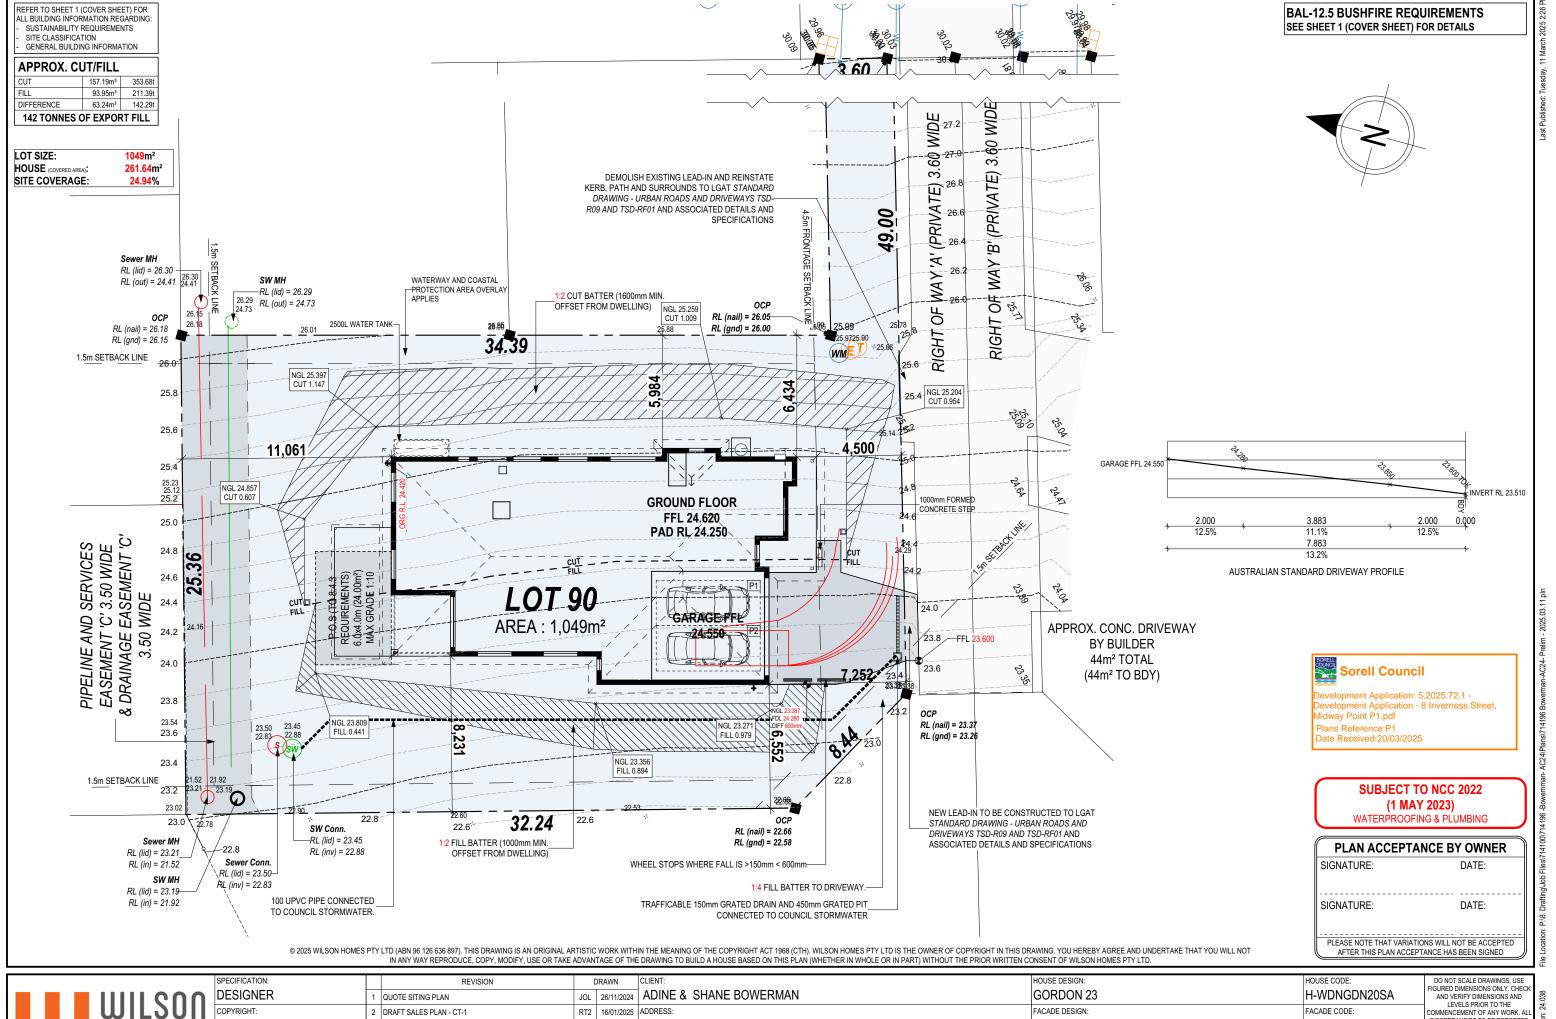
SPECIFICATION:		REVISION		DRAWN
DESIGNER	1	QUOTE SITING PLAN	JOL	26/11/20
COPYRIGHT:	2	DRAFT SALES PLAN - CT-1	RT2	16/01/202
© 2025	3	DRAFT SALES PLAN- CT-2	RT2	12/02/20
	4	PRELIM PLAN - INITIAL ISSUE	TNG	11/03/202

L	RAWN	CLIENT:
	26/11/2024	ADINE & SHANE BOV
	16/01/2025	
	12/02/2025	8 INVERNESS STREE
		LOT / SECTION / CT:
		90 / - / 184962

ADINE & SHANE BOWE	RMAN
ADDRESS:	
8 INVERNESS STREET, I	MIDWAY POINT TAS 7171
LOT / SECTION / CT:	COUNCIL:
90 / - / 184962	SORELL COUNCIL

HOUSE DESIGN:		HOUSE CODE:
GORDON 23		H-WDNGDI
FACADE DESIGN:		FACADE CODE:
NORSK		F-WDNGD1
SHEET TITLE:	SHEET No.:	SCALES:
SITE PLAN (1:500)	2 / 17	1:500

DATE:



COMMENCEMENT OF ANY WORK. AL DISCREPANCIES TO BE REPORTED TO THE DRAFTING OFFICE. NORSK RT2 | 12/02/2025 | 8 INVERNESS STREET, MIDWAY POINT TAS 7171 F-WDNGDN20NRSKA 3 DRAFT SALES PLAN- CT-2 TNG 11/03/2025 LOT / SECTION / CT: SHEET TITLE: COUNCIL SHEET No.: SCALES: 4 PRELIM PLAN - INITIAL ISSUE 714196 SORELL COUNCIL 3 / 17 1:200 90 / - / 184962 SITE PLAN (1:200)

ALL VEGETATION OUTSIDE THE BUILDING ZONE WILL BE MAINTAINED.

OWNER TO STABILISE THE SITE ON COMPLETION OF THE BUILD WITH TURF LAWNS, GRASS SEEDS, NATIVE GROUND COVERS AND/ OR MULCH SPREAD TO A DEPTH OF 75-100mm

THE FOLLOWING IS A STANDARD APPROACH. SEDIMENT AND EROSION CONTROL MEASURES WILL BE REVIEWED PRIOR TO COMMENCING WORK AND INSTALLED BASED ON THE OUTCOME OF THAT REVIEW.


1. ALL EROSION AND SEDIMENT CONTROL STRUCTURES TO BE INSPECTED EACH WORKING DAY AND MAINTAINED IN GOOD WORKING ORDER.


- 2. ALL GROUND COVER VEGETATION OUTSIDE THE IMMEDIATE BUILDING AREA TO BE PRESERVED DURING THE BUILDING
- 3. ALL EROSION AND SEDIMENT CONROL MEASURES TO BE INSTALLED PRIOR TO COMMENCEMENT OF MAJOR EARTHWORKS.
- 4. STOCKPILES OF CLAYEY MATERIAL TO BE COVERED WITH AN IMPERVIOUS SHEET. 5. ROOF WATER DOWNPIPES TO BE CONNECTED TO THE PERMAMENT UNDERGROUND STORMWATER DRAINAGE SYSTEM AS SOON AS PRACTICAL AFTER

THE ROOF IS LAID.


6. DIVERSION DRAINS ARE TO BE CONNECTED TO A LEAGAL DISCHARGE POINT (COUNCIL STORMWATER SYSTEM, WATERCOURSE OR ROAD DRAIN). 7. SEDIMENT RETENTION TRAPS INSTALLED AROUND THE INLETS TO THE STORMWATER SYSTEM TO PREVENT SEDIMENT & OTHER DEBRIS BLOCKING THE DRAINS.



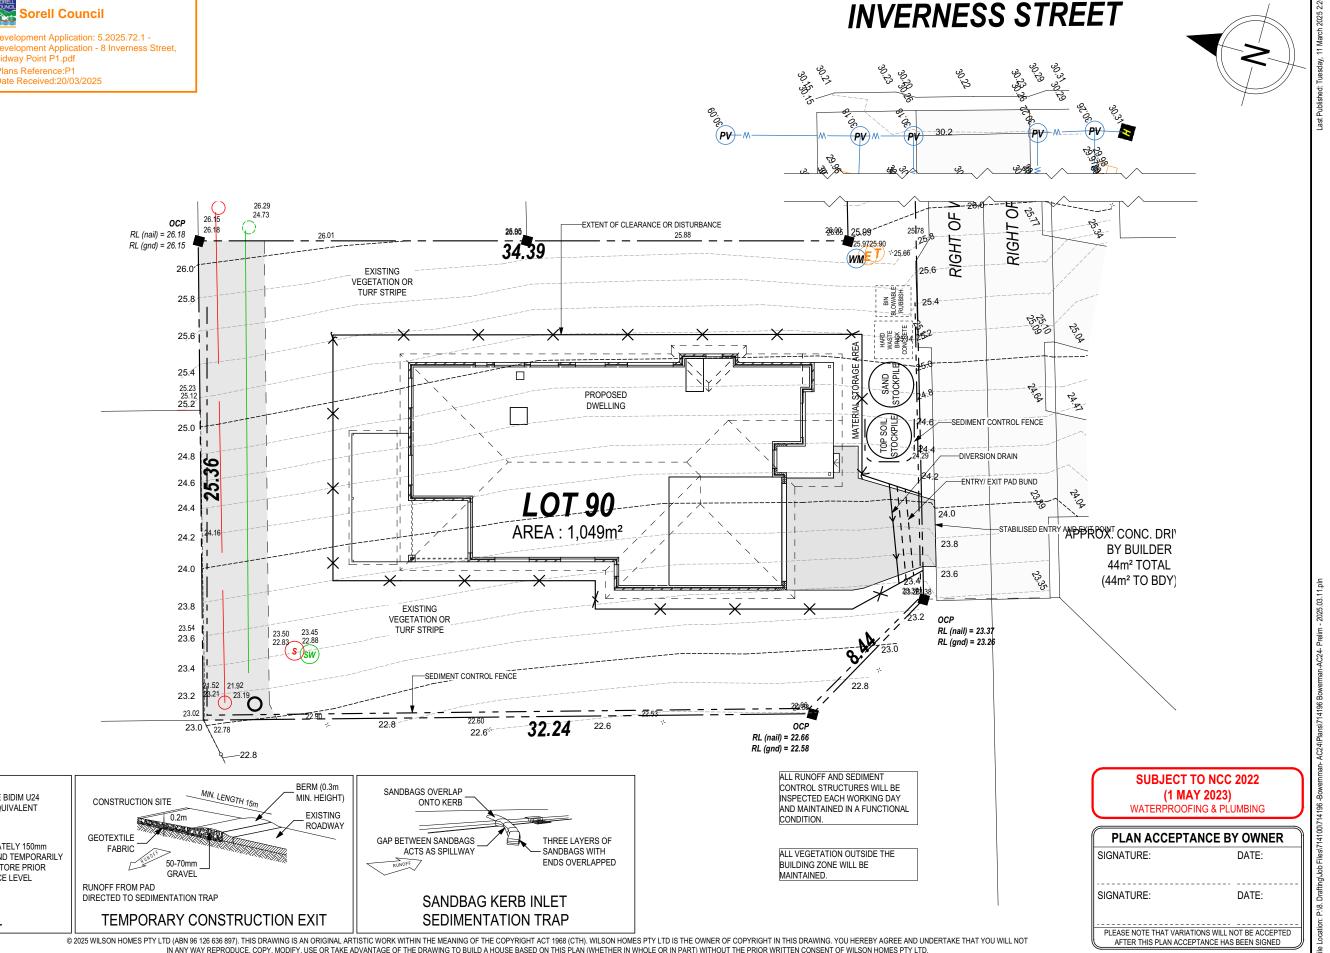

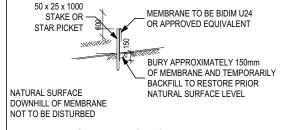


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	COPYRIGHT:	2 DRAFT SALES PLAN - CT-1	RT2	16/01/2025	ADDRESS:		FACADE DESIGN:		FACADE CODE:	LEVELS PRIOR TO THE COMMENCEMENT OF ANY WORK. AL	
	© 2025	3 DRAFT SALES PLAN- CT-2	RT2	12/02/2025	8 INVERNESS STREET,	, MIDWAY POINT TAS 7171	NORSK		F-WDNGDN20NRSKA	DISCREPANCIES TO BE REPORTED TO THE DRAFTING OFFICE.	/ersic
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	ſ				90 / - / 184962	SORELL COUNCIL	SOIL & WATER MANAGEMENT PLAN	4 / 17	1:200	714196	Temp

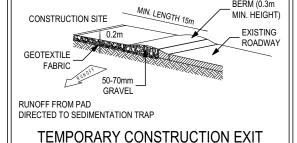

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ı	COPYRIGHT:	2 DRAFT SALES PLAN - CT-1 R	T2 16/01/2025		FACADE DESIGN:		COMMENCEMENT OF ANY WORK. ALL
_	© 2025	3 DRAFT SALES PLAN- CT-2 R	T2 12/02/2025	8 INVERNESS STREET, MIDWAY POINT TAS 7171	NORSK	F-WDNGDN20NRSKA	DISCREPANCIES TO BE REPORTED TO THE DRAFTING OFFICE.
		4 PRELIM PLAN - INITIAL ISSUE T				EET No.: SCALES:	71/106
				90 / - / 184962 SORELL COUNCIL	GROUND FLOOR PLAN 5	/ 17 1:100	714196

RL 29.563 - RIDGE LEVEL

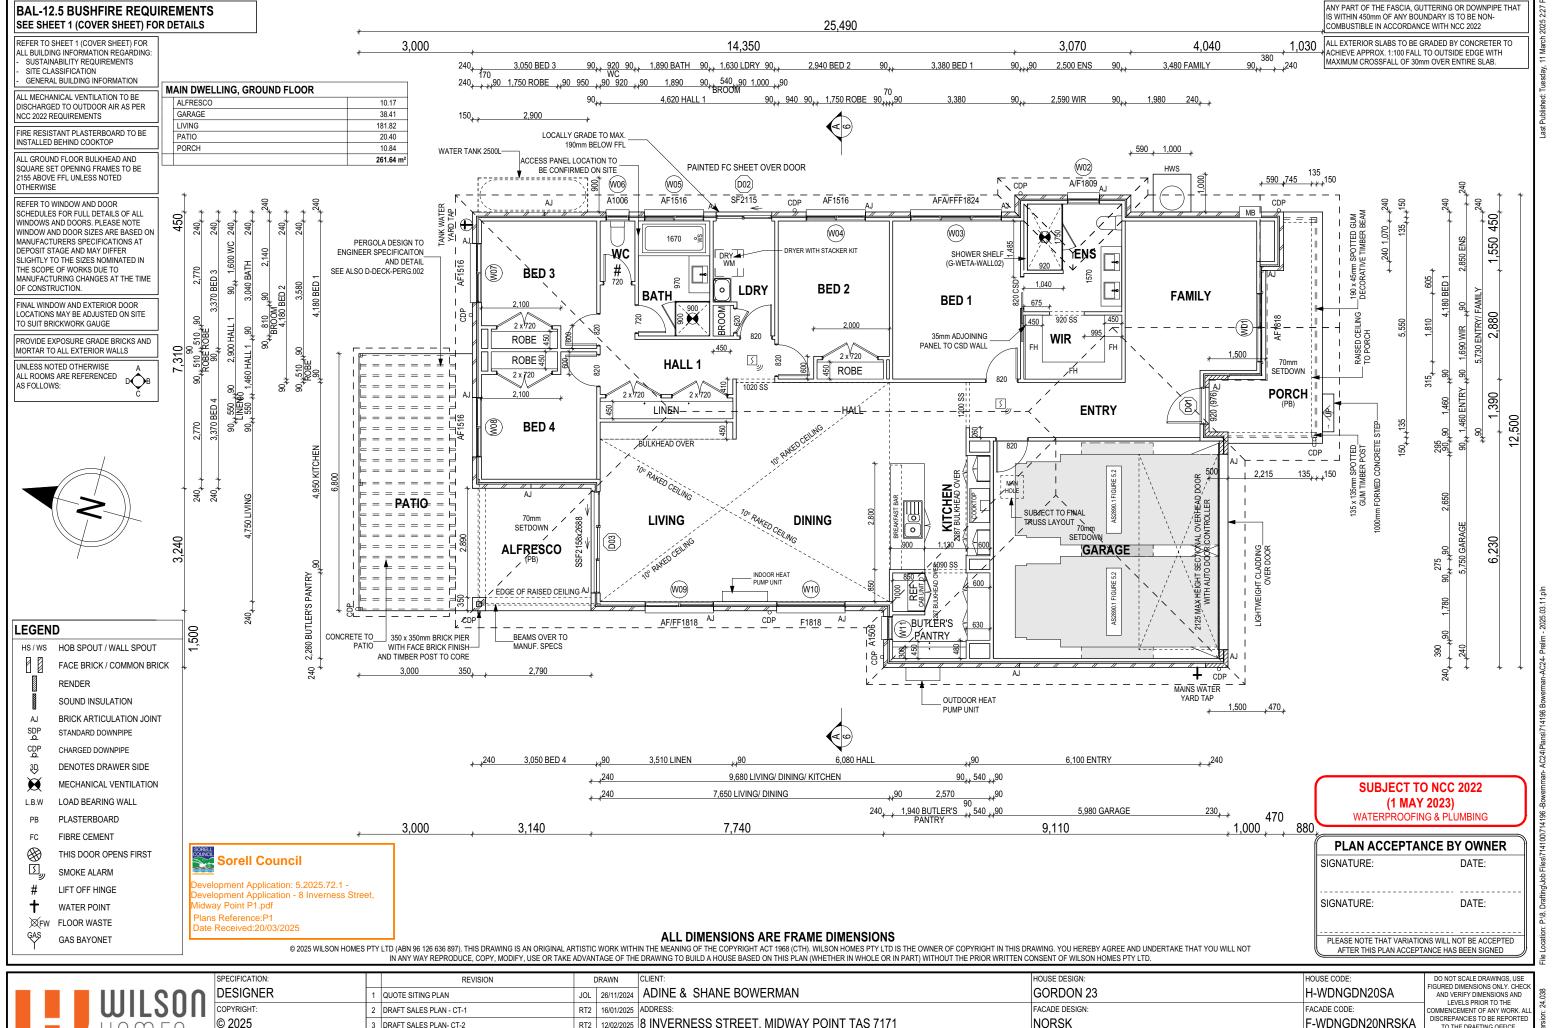RL 27.215 - TOP OF WALL

RL 24.620 - GROUND FLOOR RL 24.250 - PAD LEVEL

1:2 FILL BATTER-EXISTING GROUND LEVEL- RAKED CEILING

DINING

WALL LININGS

A SECTION A-A SCALE: 1:100

REFER ENGINEERING FOR FLOOR AND FOOTING DETAILS

FC SHEETING-

REFER TO SHEET 1 (COVER SHEET) FOR ALL BUILDING INFORMATION REGARDING:

SUSTAINABILITY REQUIREMENTS SITE CLASSIFICATION GENERAL BUILDING INFORMATION SOME DETAILS ON THIS SHEET ARE INDICATIVE ONLY FOR EXAMPLE BRICKWORK AND CLADDING (EXPANSION JOINTS, ORIENTATION AND LAYOUT) AND

ARE SUBJECT TO CHANGE. SH = SNAP HEADER SILL BEDROOM WINDOW OPENINGS ABOVE 2m OFF THE SURFACE BENEATH TO BE RESTRICTED AS REQUIRED BY NCC 11.3.7 (VOLUME

ROOMS OTHER THAN BEDROOM WINDOW OPENINGS ABOVE 4m OFF THE SURFACE BENEATH TO BE RESTRICTED AS REQUIRED BY NCC

REFER TO THE FOLLOWING DETAILS: BRICK COURSING W-BRIC-001

11.3.7 (VOLUME TWO)

WATERPROOFING & PLUMBING

PLAN ACCEPTANCE BY OWNER

SIGNATURE: DATE:

SIGNATURE: DATE:

PLEASE NOTE THAT VARIATIONS WILL NOT BE ACCEPTED

GLASS TYPE LEGEND DOUBLE CLEAR OBSCURE HUNG © 2025 WILSON HOMES PTY LTD (ABN 96 126 636 897). THIS DRAWING IS AN ORIGINAL ARTISTIC WORK WITHIN THE MEANING OF THE COPYRIGHT ACT 1968 (CTH). WILSON HOMES PTY LTD IS THE OWNER OF COPYRIGHT IN THIS DRAWING. YOU HEREBY AGREE AND UNDERTAKE THAT YOU WILL NOT

COLORBOND CORRUGATED / -CUSTOM ORB METAL ROOFING + FOIL FACED BLANKET

PLASTERBOARD CEILING LININGS

BED 2

MANUFACTURED TIMBER TRUSSES

FIXED LOUVRE SLIDING

WINDOW TYPE LEGEND

—1:2 CUT BATTER

AFTER THIS PLAN ACCEPTANCE HAS BEEN SIGNED

Sorell Council

idway Point P1.pdf


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ate Received:20/03/2025

elopment Application: 5.2025.72.1 - elopment Application - 8 Inverness Street,

AND VERIFY DIMENSIONS AND LEVELS PRIOR TO THE COMMENCEMENT OF ANY WORK. AL DISCREPANCIES TO BE REPORTED TO THE DRAFTING OFFICE.

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TNG 11/03/2025 LOT / SECTION / CT:

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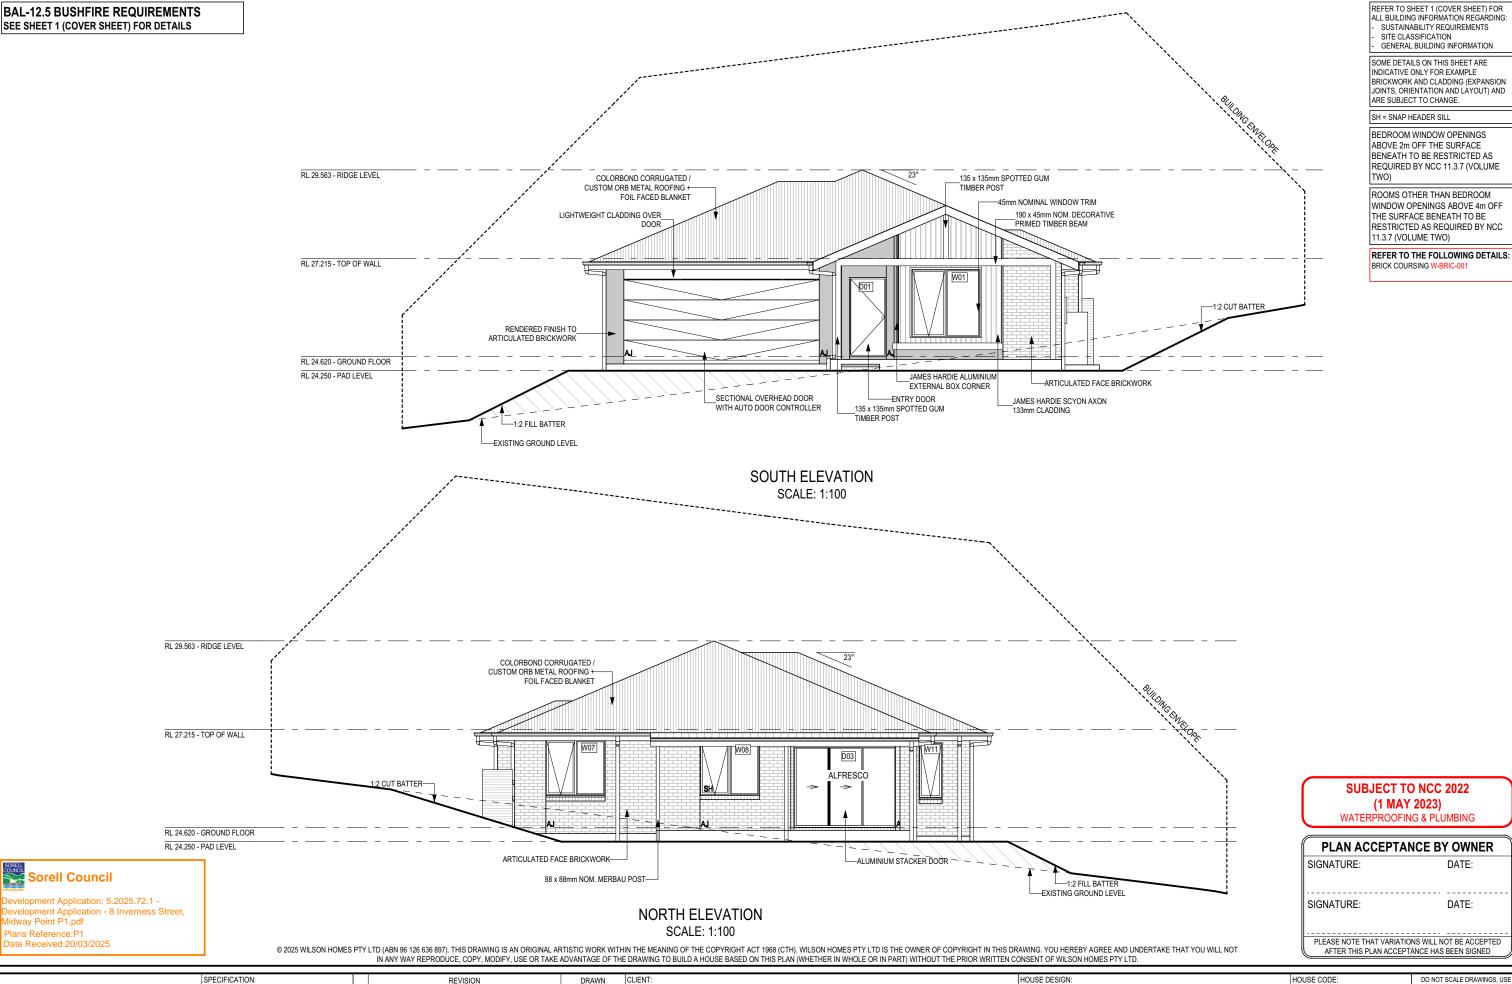
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JOL 26/11/2024 ADINE & SHANE BOWERMAN
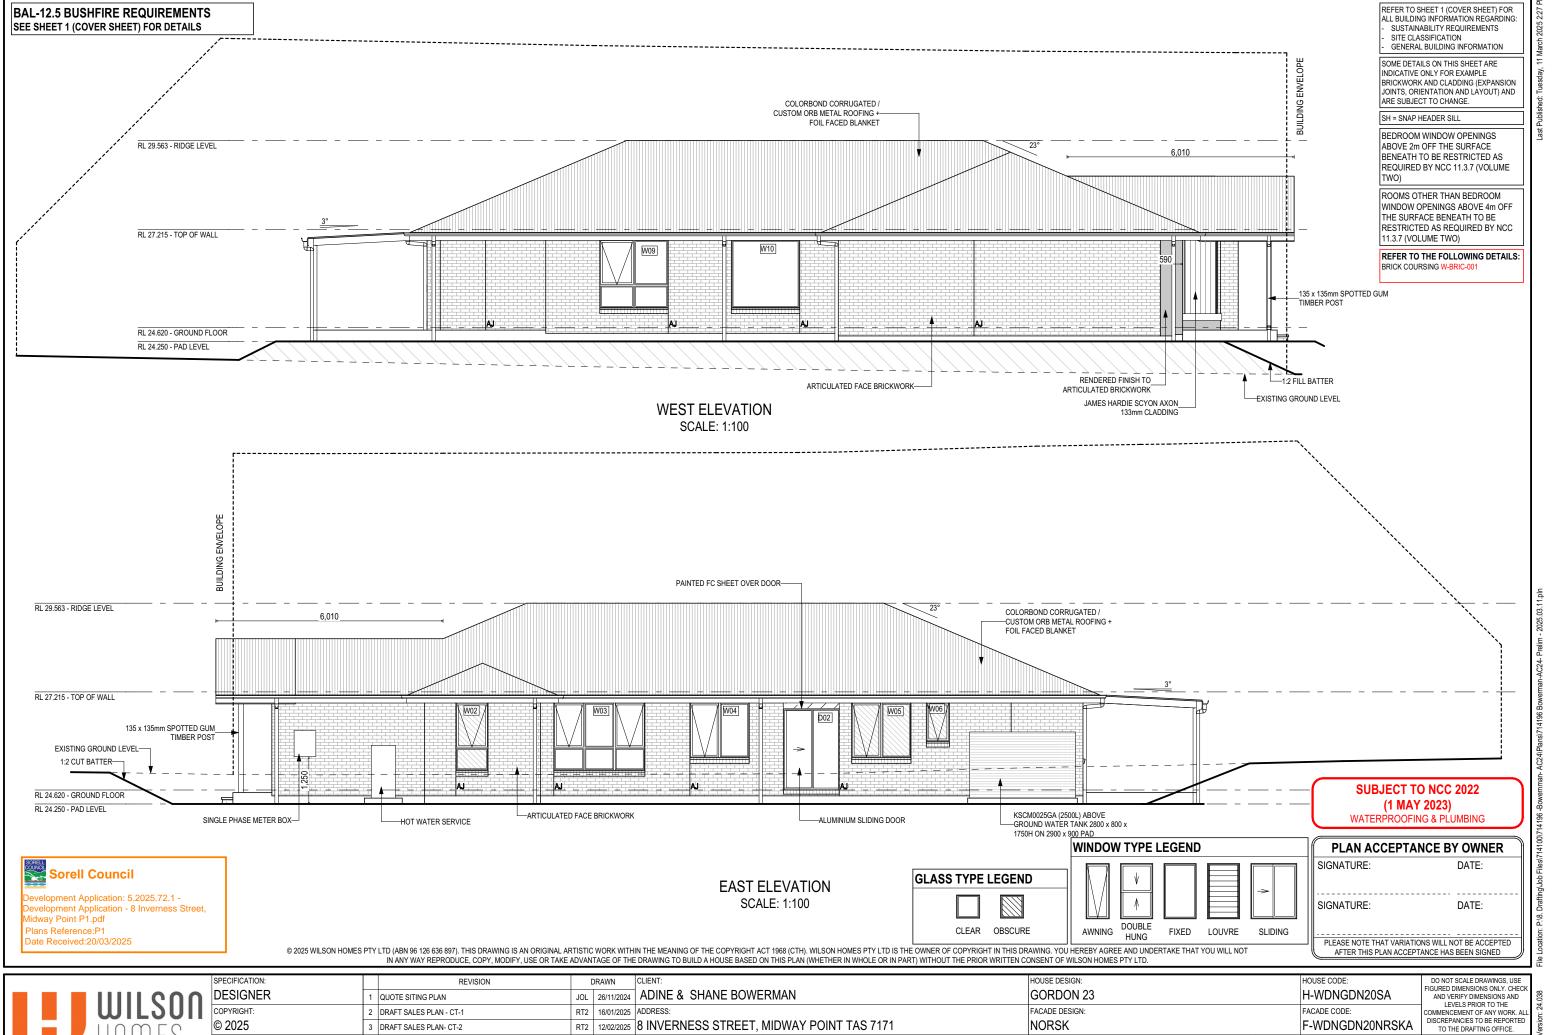
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RT2 12/02/2025 8 INVERNESS STREET, MIDWAY POINT TAS 7171

COUNCIL:

SORELL COUNCIL

RT2 16/01/2025 ADDRESS:

TNG 11/03/2025 LOT / SECTION / CT:

DESIGNER

QUOTE SITING PLAN

2 DRAFT SALES PLAN - CT-1

3 DRAFT SALES PLAN- CT-2

4 PRELIM PLAN - INITIAL ISSUE

OUSE DESIGN HOUSE CODE DO NOT SCALE DRAWINGS, USE FIGURED DIMENSIONS ONLY, CHECK GORDON 23 H-WDNGDN20SA AND VERIFY DIMENSIONS AND I EVELS PRIOR TO THE FACADE DESIGN: FACADE CODE: COMMENCEMENT OF ANY WORK. AL DISCREPANCIES TO BE REPORTED TO THE DRAFTING OFFICE. NORSK F-WDNGDN20NRSKA SHEET TITLE: SHEET No.: SCALES: 714196 **ELEVATIONS** 8 / 17 1:100

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ent Application: 5.2025.72.1 evelopment Application - 8 Inverness Street, Aidway Point P1.pdf Plans Reference:P1 Date Received:20/03/2025

Provide BAL-12.5 rated aluminium windows and external glass sliding doors in lieu of standard.

Provide flyscreens with corrosion resistant mesh to all opening window sashes only.

PICTURE, TV RECESS AND SS WINDOW OPENINGS

HEIGHT | WIDTH | AREA (m²)

Manufacturer - Clark Windows			
Window Type	Glazing	U-Value	SHGC
Awning	Single	6.5	0.67
	Double	4.1	0.57
Fixed	Single	5.9	0.75
	Double	3.2	0.67
Sliding	Single	6.4	0.76
	Double	4.2	0.59
Fixed Pane	Single	5.9	0.75
	Double	3.2	0.67
Fixed Glass Panel Hinged Door	Single	6.0	0.62
	Double	4.3	0.55
Sliding Door	Single	6.1	0.74
	Double	3.6	0.66
Stacking Door	Single	6.3	0.74
	Double	3.8	0.66
135 deg. Awning Bay Window	Single	6.5	0.67
	Double	4.1	0.57
135 deg. Sliding Bay Window	Single	6.5	0.76
	Double	4.2	0.59
90 deg. Awning Bay Window	Single	6.5	0.67
	Double	4.1	0.57
90 deg. Sliding Bay Window	Single	6.5	0.76
	Double	4.2	0.59
Bifold Doors	Single	6.1	0.61
	Double	4.4	0.53

Windows supplied MUST HAVE Uw better and or equal to stated figures and SHGC within +/- 5% of stated figures. Restricted windows to have their openability restricted as per N.C.C 11.3.6.

> **SUBJECT TO NCC 2022** (1 MAY 2023)

WATERPROOFING & PLUMBING

PLAN ACCEPTANCE BY OWNER

FLAN ACCLF TANCE D	OWNER
SIGNATURE:	DATE:
SIGNATURE:	DATE:

PLEASE NOTE THAT VARIATIONS WILL NOT BE ACCEPTED AFTER THIS PLAN ACCEPTANCE HAS BEEN SIGNED.

ı	NTERIOR WIND	WO	& DOOR SCHEDULE									
Г	STOREY	QTY	CODE	TYPE	HEIGHT	WIDTH	GLAZING TYPE	ADDITIONAL INFORMATION				
I	DOOR											
	GROUND FLOOR	1	1020 SS	SQUARE SET OPENING	2,155	1,020	N/A					
	GROUND FLOOR	1	1090 SS	SQUARE SET OPENING	2,155	1,090	N/A					
	GROUND FLOOR	1	1200 SS	SQUARE SET OPENING	2,155	1,200	N/A					
	GROUND FLOOR	5	2 x 720	SWINGING	2,040	1,440	N/A					
	GROUND FLOOR	1	620	SWINGING	2,040	620	N/A					
	GROUND FLOOR	1	720	SWINGING	2,040	720	N/A					
	GROUND FLOOR	1	720	SWINGING	2,040	720	N/A	LIFT-OFF HINGES				
	GROUND FLOOR	6	820	SWINGING	2,040	820	N/A					
	GROUND FLOOR	1	820 CSD	CAVITY SLIDING	2,040	820	N/A					
	GROUND FLOOR	1	920 SS	SQUARE SET OPENING	2,155	920	N/A					

NOTE: INTERNAL DOORS TO WET AREAS WITH MECHANICAL VENTILATION TO BE UNDERCUT 20mm

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BAL-12.5 BUSHFIRE REQUIREMENTS

SEE SHEET 1 (COVER SHEET) FOR DETAILS

REFER TO SHEET 1 (COVER SHEET) FOR

ALL BUILDING INFORMATION REGARDING:


SUSTAINABILITY REQUIREMENTS

GENERAL BUILDING INFORMATION

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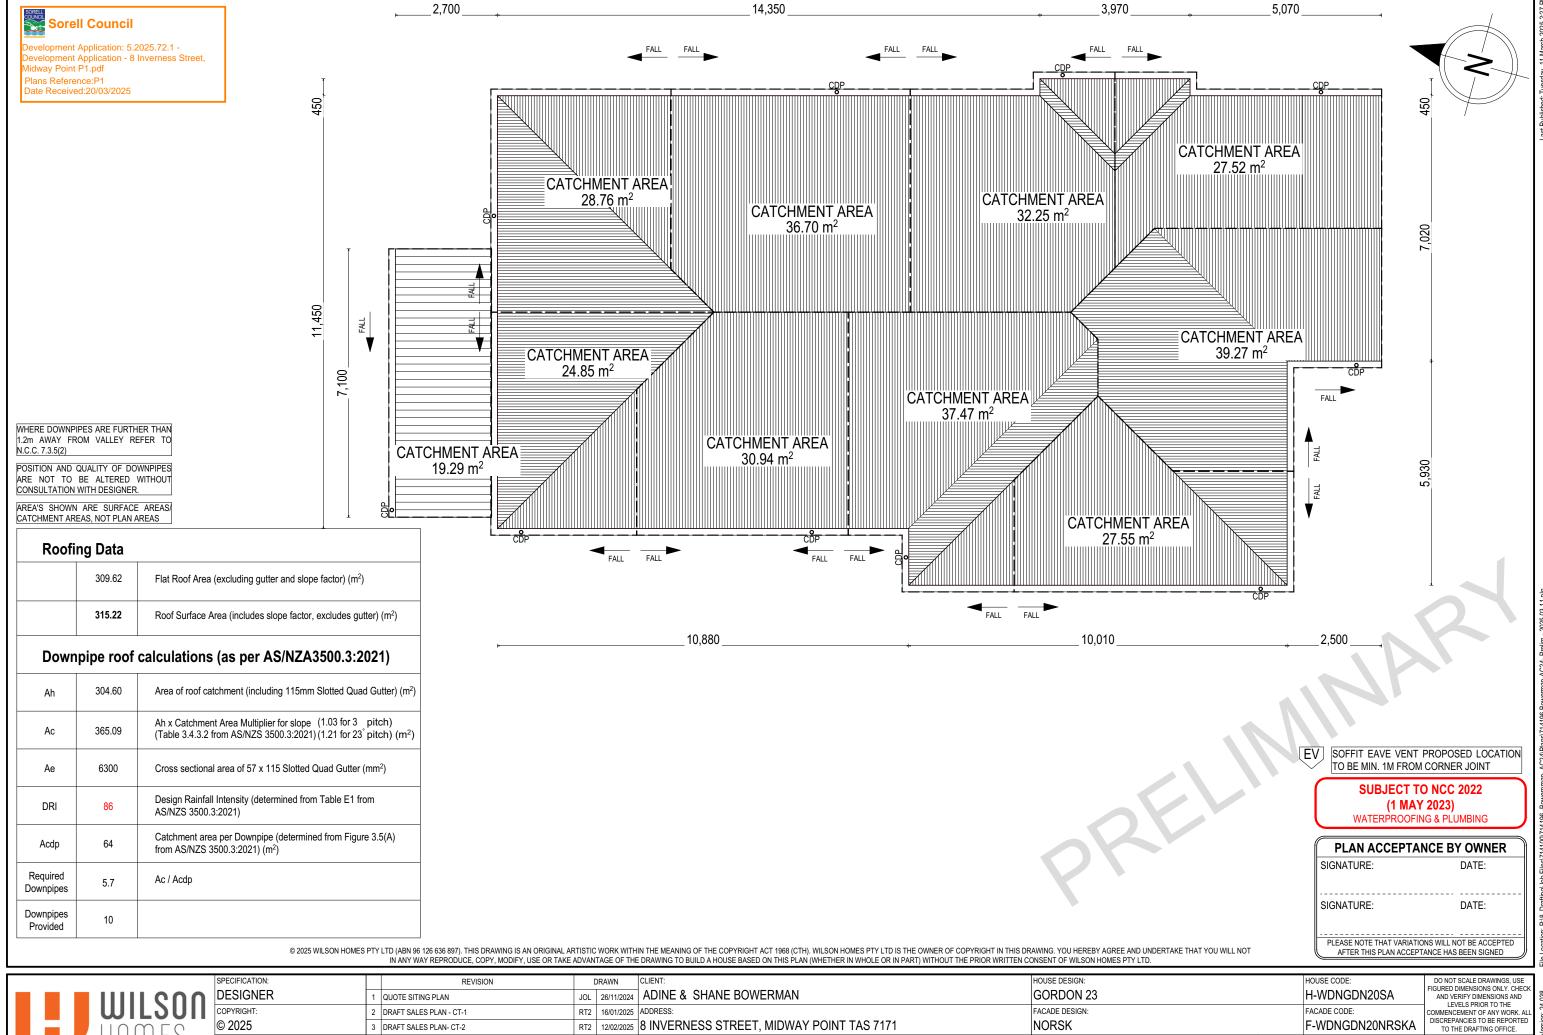
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n	DESIGNER	1 QUOTE SITING PLAN	JOL	26/11/2024 ADINE & SHANE BOWERMAN	GORDON 23	H-WDNGDN20SA	FIGURED DIMENSIONS ONLY. CHECK AND VERIFY DIMENSIONS AND LEVELS PRIOR TO THE	.038
ш	COPYRIGHT:	2 DRAFT SALES PLAN - CT-1	RT2	16/01/2025 ADDRESS:	FACADE DESIGN:	FACADE CODE:	COMMENCEMENT OF ANY WORK. ALL	n: 24
_	© 2025	3 DRAFT SALES PLAN- CT-2	RT2	12/02/2025 8 INVERNESS STREET, MIDWAY POINT TAS 7171	NORSK	F-WDNGDN20NRSKA	DISCREPANCIES TO BE REPORTED TO THE DRAFTING OFFICE.	/ersic
		4 PRELIM PLAN - INITIAL ISSUE	TNG	11/03/2025 LOT / SECTION / CT: COUNCIL:	SHEET TITLE: SHEET No.	SCALES:	714196	late
				90 / - / 184962 SORELL COUNCIL	WINDOW & DOOR SCHEDULES 9 / 17		114190	emp

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RT2 | 12/02/2025 | 8 INVERNESS STREET, MIDWAY POINT TAS 7171

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3 DRAFT SALES PLAN- CT-2
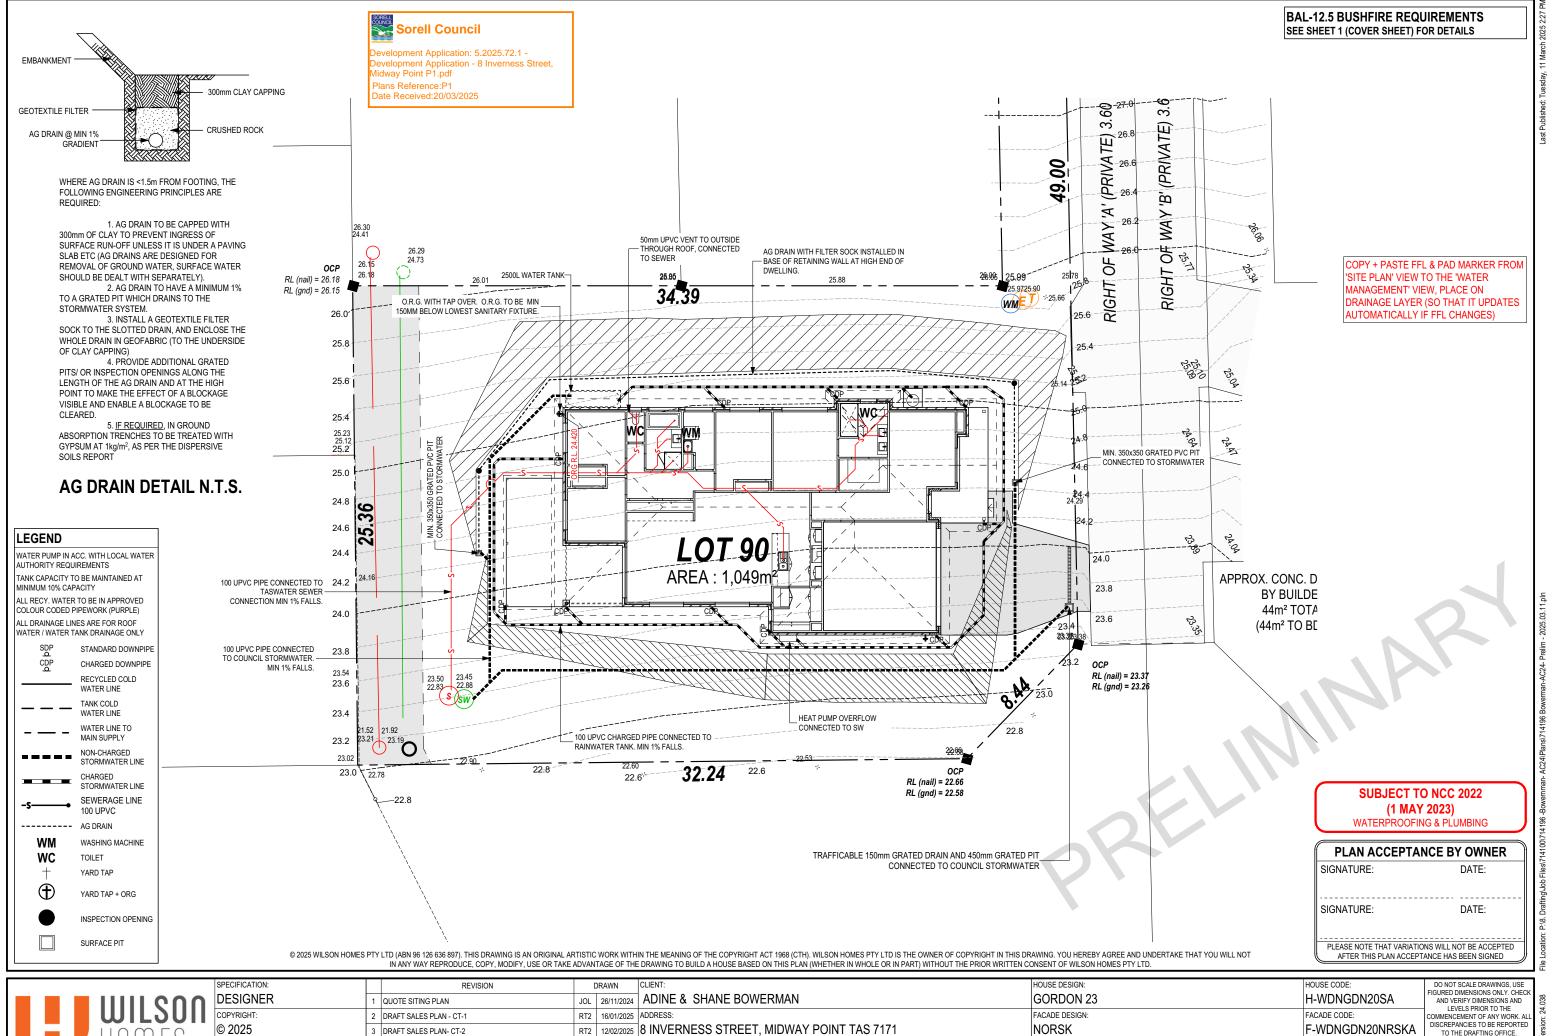
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11 / 17 | 1:100

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FLOOR TILES SHOWN ON PLAN DO NOT INDICATE THE SIZE OR JOINT LOCATIONS OF THE ACTUAL FLOOR TILES.
TIMBER FLOORING SHOWN ON PLAN DOES NOT INDICATE THE BOARD SIZE OR DIRECTION OF THE ACTUAL FLOORING.

COVERINGS LEGEND

NO COVERING

COVER GRADE CONCRETE

CARPET

LAMINATE

TILE (STANDARD WET AREAS)

TILE (UPGRADED AREAS)

DECKING



SIGNATURE: DATE: SIGNATURE: DATE: PLEASE NOTE THAT VARIATIONS WILL NOT BE ACCEPTED

AFTER THIS PLAN ACCEPTANCE HAS BEEN SIGNED

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SHEET TITLE:

FLOOR COVERINGS

BAL-12.5 BUSHFIRE REQUIREMENTS SEE SHEET 1 (COVER SHEET) FOR DETAILS

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3 DRAFT SALES PLAN- CT-2

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COPYRIGHT:	2	DRAFT SALES PLAN - CT-1	RT2	16/01/2025 ADDRESS:	FACADE DESIGN:					

RT2 | 12/02/2025 | 8 INVERNESS STREET, MIDWAY POINT TAS 7171

TNG 11/03/2025 LOT / SECTION / CT:


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	HOUSE CODE: H-WDNGDN20SA	DO NOT SCALE DRAWINGS, USE FIGURED DIMENSIONS ONLY. CHECK AND VERIFY DIMENSIONS AND LEVELS PRIOR TO THE
	FACADE CODE: F-WDNGDN20NRSKA	COMMENCEMENT OF ANY WORK, ALL DISCREPANCIES TO BE REPORTED TO THE DRAFTING OFFICE.
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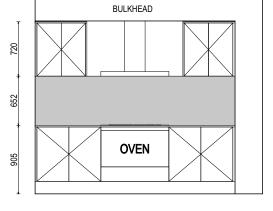
velopment Application: 5.2025.72.1 - velopment Application - 8 Inverness Street, dway Point P1.pdf Plans Reference:P1 ate Received:20/03/2025

REFER TO SHEET 1 (COVER SHEET) FOR ALL BUILDING INFORMATION REGARDING: SUSTAINABILITY REQUIREMENTS SITE CLASSIFICATION GENERAL BUILDING INFORMATION


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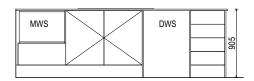
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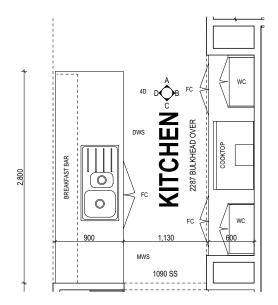
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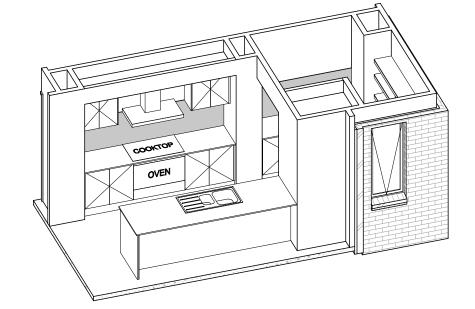
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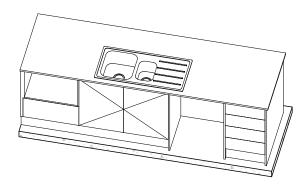


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(1 MAY 2023) WATERPROOFING & PLUMBING

SUBJECT TO NCC 2022

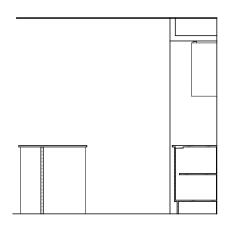PLAN ACCEPTA	ANCE BY OWNER				
SIGNATURE:	DATE:				
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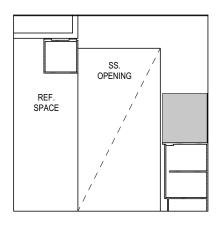
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ш		DRAFT SALES PLAN - CT-1	RT2	16/01/2025 ADDRESS:			FACADE DESIGN:			FACADE CODE:	LEVELS PRIOR TO THE COMMENCEMENT OF ANY WORK. ALL	n: 24
_	© 2025	DRAFT SALES PLAN- CT-2	RT2	12/02/2025 8 INVERNESS STREET	8 INVERNESS STREET, MIDWAY POINT TAS 7171		NORSK			F-WDNGDN20NRSKA	DISCREPANCIES TO BE REPORTED TO THE DRAFTING OFFICE.	/ersio
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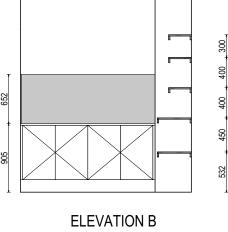
opment Application: 5.2025.72.1 velopment Application - 8 Inverness Street, idway Point P1.pdf Plans Reference:P1 Date Received:20/03/2025

REFER TO SHEET 1 (COVER SHEET) FOR ALL BUILDING INFORMATION REGARDING: SUSTAINABILITY REQUIREMENTS SITE CLASSIFICATION GENERAL BUILDING INFORMATION

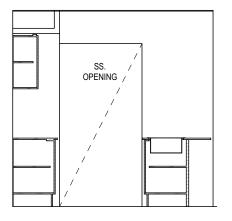
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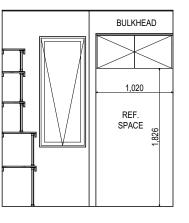
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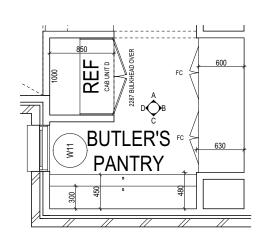
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ELEVATION C SCALE: 1:50



ELEVATION D SCALE: 1:50



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	SPECIFICATION:	REVISION	REVISION DRAWN CLIENT: HOUSE DESIGN:		HOUSE CODE:	DO NOT SCALE DRAWINGS, USE			
1	DESIGNER 1	QUOTE SITING PLAN	JOL 26/11/2024 ADINE & SHANE BOWERMAN	GORDON 23	H-WDNGDN20SA	FIGURED DIMENSIONS ONLY. CHECK AND VERIFY DIMENSIONS AND			
ı			RT2 16/01/2025 ADDRESS:	FACADE DESIGN:		LEVELS PRIOR TO THE COMMENCEMENT OF ANY WORK. ALL			
_	© 2025	DRAFT SALES PLAN- CT-2	RT2 12/02/2025 8 INVERNESS STREET, MIDWAY POINT TAS 7171	NORSK	F-WDNGDN20NRSKA	DISCREPANCIES TO BE REPORTED TO THE DRAFTING OFFICE.			
	4	PRELIM PLAN - INITIAL ISSUE	TNG 11/03/2025 LOT / SECTION / CT: COUNCIL:	SHEET TITLE: SHEET No.:		71/106			
			90 / - / 184962 SORELL COUNCIL	BUTLER'S PANTRY DETAILS 14 / 17	1:50	714196			

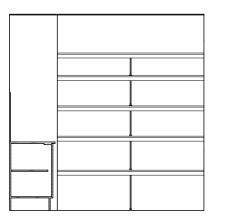STANDARD BATH HOB D-WETA-BATH003
WET AREA TILING LAYOUTS D-WETA-TILE002 SQUARE SET WINDOWS G-WIND-SSET02 FULL HEIGHT TILING D-LINI-WETA

SITE CLASSIFICATION GENERAL BUILDING INFORMATION

REFER TO SHEET 1 (COVER SHEET) FOR ALL BUILDING INFORMATION REGARDING:

SUSTAINABILITY REQUIREMENTS

LEGEND


DETAILS DEPICTED ON THIS SHEET ARE A REPRESENTATION ONLY




evelopment Application: 5.2025.72.1 - evelopment Application - 8 Inverness Street,




idway Point P1.pdf Plans Reference:P1

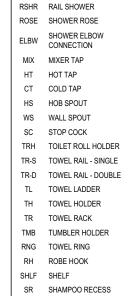

SOAP SOAP HOLDER

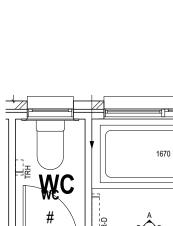

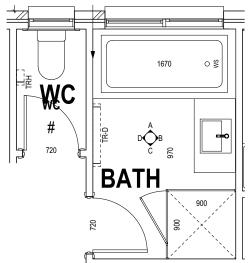

BATHROOM PLAN SCALE: 1:50


SHAMPOO	RECESS SIZE	STRUCTURA	L DIMENSIONS
		WIDTH	HEIGHT
"SMALL"	470 x 380mm	548mm	446mm
"MEDIUM"	800 x 380mm	878mm	446mm
"LARGE"	1500 x 380mm	1578mm	446mm
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FURTHER DETAIL PRIOR TO INSTALLATION.


SUBJECT TO NCC 2022 (1 MAY 2023)

WATERPROOFING & PLUMBING


PLAN ACCEPTANCE BY OWNER							
SIGNATURE: DATE:							
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PLEASE NOTE THAT VARIATIONS WILL NOT BE ACCEPTED							
AFTER THIS PLAN ACCE	PTANCE HAS BEEN SIGNED						

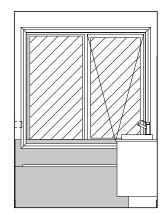


ELEVATION A SCALE: 1:50

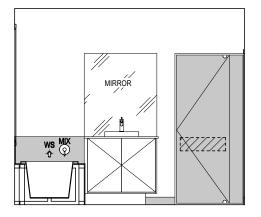

ELEVATION B SCALE: 1:50

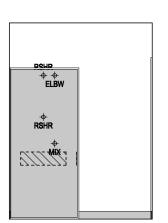

ELEVATION C SCALE: 1:50

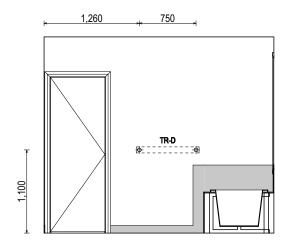

ELEVATION D SCALE: 1:50

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SPECIFICATION:	REVISION	DRAWN CLIENT:	HOUSE DESIGN:	HOUSE CODE:	DO NOT SCALE DRAWINGS, USE
DESIGNER	1 QUOTE SITING PLAN	JOL 26/11/2024 ADINE & SHANE BOWERMAN	GORDON 23	H-WDNGDN20SA	FIGURED DIMENSIONS ONLY. CHECK AND VERIFY DIMENSIONS AND LEVELS PRIOR TO THE
COPYRIGHT:	2 DRAFT SALES PLAN - CT-1	RT2 16/01/2025 ADDRESS:	FACADE DESIGN:	FACADE CODE:	COMMENCEMENT OF ANY WORK. ALL
© 2025	3 DRAFT SALES PLAN- CT-2	RT2 12/02/2025 8 INVERNESS STREET, MIDWAY POINT TAS 7171	NORSK	F-WDNGDN20NR	SKA DISCREPANCIES TO BE REPORTED TO THE DRAFTING OFFICE.
	4 PRELIM PLAN - INITIAL ISSUE	TNG 11/03/2025 LOT / SECTION / CT: COUNCIL:	SHEET TITLE:	SHEET No.: SCALES:	714196
		90 / - / 184962 SORELL COUNCIL	BATHROOM DETAILS	15 / 17 1:50	114190

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LEGEND

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RSHR RAIL SHOWER ROSE SHOWER ROSE

ELBW SHOWER ELBOW CONNECTION


HOT TAP

MIX MIXER TAP




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ate Received:20/03/2025

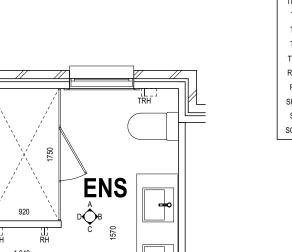


CT COLD TAP HS HOB SPOUT WS WALL SPOUT SC STOP COCK TRH TOILET ROLL HOLDER TR-S TOWEL RAIL - SINGLE TR-D TOWEL RAIL - DOUBLE TL TOWEL LADDER TH TOWEL HOLDER TR TOWEL RACK TMB TUMBLER HOLDER RNG TOWEL RING RH ROBE HOOK SHLF SHELF SR SHAMPOO RECESS SOAP SOAP HOLDER

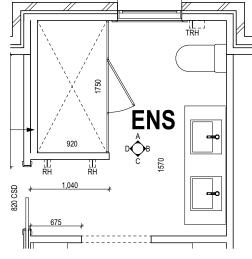

ENSUITE PLAN

SCALE: 1:50

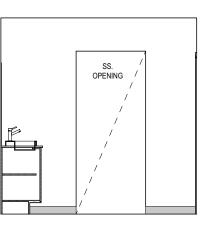


ELEVATION A

SCALE: 1:50

- 450 →

ELEVATION C SCALE: 1:50

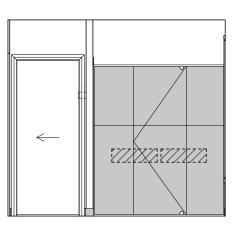

ELEVATION B

SCALE: 1:50

ELEVATION D SCALE: 1:50

SHAMPOO	RECESS SIZE	STRUCTURAL	DIMENSIONS
		WIDTH	HEIGHT
"SMALL"	470 x 380mm	548mm	446mm
"MEDIUM"	800 x 380mm	878mm	446mm
"LARGE"	1500 x 380mm	1578mm	446mm
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REFER WILSON HOMES' DETAIL G-WETA-TILE01 FOR FURTHER DETAIL PRIOR TO INSTALLATION.

SUBJECT TO NCC 2022 (1 MAY 2023)

WATERPROOFING & PLUMBING

CIONATURE						
SIGNATURE: DATE:						
SIGNATURE:	DATE:					

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SPECIFICATION: DESIGNER	REVISION 1 QUOTE SITING PLAN	VISION DRAWN CLIENT: HOUSE DESIGN: JOL 26/11/2024 ADINE & SHANE BOWERMAN GORDON 23			HOUSE CODE: H-WDNGDN20SA	DO NOT SCALE DRAWINGS, USE FIGURED DIMENSIONS ONLY. CHECK AND VERIFY DIMENSIONS AND		
COPYRIGHT:	2 DRAFT SALES PLAN - CT-1 3 DRAFT SALES PLAN - CT-2	RT2 16/01/202		FACADE DESIGN: NORSK	FACADE DESIGN: FACADE CODE:		LEVELS PRIOR TO THE COMMENCEMENT OF ANY WORK. ALL DISCREPANCIES TO BE REPORTED	
0 2020	4 PRELIM PLAN - INITIAL ISSUE		5 LOT/SECTION/CT: COUNCIL: 90 / - / 184962 SORELL COUNCIL	SHEET TITLE: ENSUITE DETAILS	SHEET No.:		714196	


Date Received:20/03/2025

idway Point P1.pdf Plans Reference:P1


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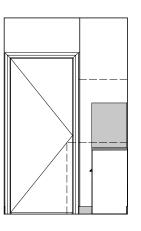
PROVIDE ADDITIONAL NOGGING TO LAUNDRY FOR FIXING OF WALL MOUNTED CLOTHES DRYER AS PER D-FRAM-ELEC006




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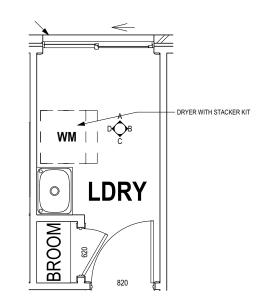
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ELEVATION C SCALE: 1:50

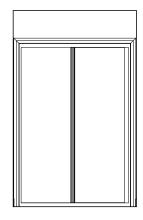

ELEVATION D SCALE: 1:50

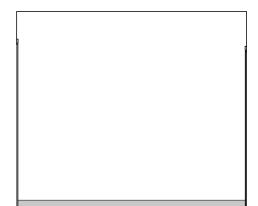

LAUNDRY PLAN SCALE: 1:50

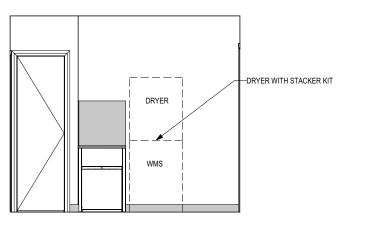SUBJECT TO NCC 2022 (1 MAY 2023) WATERPROOFING & PLUMBING

NCE BY OWNER								
DATE:								
DATE:								
PLEASE NOTE THAT VARIATIONS WILL NOT BE ACCEPTED								

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COPYRIGHT:	2 DRAFT SALES PLAN - CT-1	RT2 16/01/2025 ADDRESS:		FACADE DESIGN:			COMMENCEMENT OF ANY WORK. ALL	on: 24
© 2025	3 DRAFT SALES PLAN- CT-2	RT2 12/02/2025 8 INVERNESS STRI	EET, MIDWAY POINT TAS 7171	NORSK		F-WDNGDN20NRSKA	DISCREPANCIES TO BE REPORTED TO THE DRAFTING OFFICE.	Versic
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