

NOTICE OF PROPOSED DEVELOPMENT

Notice is hereby given that an application has been made for planning approval for the following development:

SITE: 41 Bay Street, Dunalley

PROPOSED DEVELOPMENT:

DWELLING & OUTBUILDING

The relevant plans and documents can be inspected at the Council Offices at 47 Cole Street, Sorell during normal office hours, or the plans may be viewed on Council's website at www.sorell.tas.gov.au until Monday 3rd March 2025.

Any person may make representation in relation to the proposal by letter or electronic mail (sorell.council@sorell.tas.gov.au) addressed to the General Manager. Representations must be received no later than **Monday 3rd March 2025**

APPLICANT: Threshold Building Design

APPLICATION NO: DA 2025 / 2 1

DATE: 14 February 2025

Part B: Please note that Part B of this form is publicly exhibited.

Full description of Proposal:	Use:					
5 op 555	Development:					
	Large or complex proposals s	should be des	scribed	in a letter or planning report.		
Design and cons	\$					
Is all, or some th	ne work already constructed	: No): L	Yes:		
Location of proposed		eet address:				
works:				code:		
Certificate of Title(s) Volume: Folio:				Folio:		
Current Use of Site						
Current Owner/s:	Name(s)					
Is the Property on the Tasmanian Heritage Register?		No: □ Ye	es: 🗆	If yes, please provide written advice from Heritage Tasmania		
Is the proposal to be carried out in more than one stage?		No: □ Ye	es: 🗆	If yes, please clearly describe in plans		
Have any potentially contaminating uses been undertaken on the site?		No: ☐ Ye	es: 🗆	If yes, please complete the Additional Information for Non-Residential Use		
Is any vegetation proposed to be removed?		No: □ Ye	es: 🗆	If yes, please ensure plans clearly show area to be impacted		
Does the proposal involve land administered or owned by either the Crown or Council?		No: □ Ye	es: 🗆	If yes, please complete the Council or Crown land section on page 3		
If a new or upgraded vehicular crossing is required from Council to the front boundary please						
complete the Vehicular Crossing (and Associated Works) application form https://www.sorell.tas.gov.au/services/engineering/						
nttps://www.soren.tas.gov.au/services/engineering/						

Sorell Council

Development Application: Development Application - 41 Bay Street, Dunalley.pdf

Plans Reference:P1
Date Received:6/01/2025

Declarations and acknowledgements

- I/we confirm that the application does not contradict any easement, covenant or restriction specified in the Certificate of Title, Schedule of Easements or Part 5 Agreement for the land.
- I/we consent to Council employees or consultants entering the site and have arranged permission and/or access for Council's representatives to enter the land at any time during normal business hours.
- I/we authorise the provision of a copy of any documents relating to this application to any person for the purposes of assessment or public consultation and have permission of the copyright owner for such copies.
- I/we declare that, in accordance with s52(1) of the Land Use Planning and Approvals Act 1993, that I have notified the owner(s) of the intention to make this application.
- I/we declare that the information in this application is true and correct.

Details of how the Council manages personal information and how you can request access or corrections to it is outlined in Council's Privacy Policy available on the Council website.

- I/we acknowledge that the documentation submitted in support of my application will become a public record held by Council and may be reproduced by Council in both electronic and hard copy format in order to facilitate the assessment process, for display purposes during public exhibition, and to fulfil its statutory obligations. I further acknowledge that following determination of my application, Council will store documentation relating to my application in electronic format only.
- Where the General Manager's consent is also required under s.14 of the *Urban Drainage Act 2013*, by making this application I/we also apply for that consent.

Applicant Signature:	Signature: Date:
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Crown or General Manager Land Owner Consent

If the land that is the subject of this application is owned or administered by either the Crown or Sorell Council, the consent of the relevant Minister or the Council General Manager whichever is applicable, must be included here. This consent should be completed and signed by either the General Manager, the Minister, or a delegate (as specified in s52 (1D-1G) of the *Land Use Planning and Approvals Act 1993*).

Please note:

- If General Manager consent if required, please first complete the General Manager consent application form available on our website www.sorell.tas.gov.au
- If the application involves Crown land you will also need a letter of consent.
- Any consent is for the purposes of making this application only and is not consent to undertaken work or take any other action with respect to the proposed use or development.

I		being responsible for the
administration of land at declare that I have given permis	Sorell Council Development Application: Development Application - 41 Bay Street, Dunalley.pdf	
Signature of General Manager, Minister or Delegate:	Signature:	Plans Reference:P1 Date Received:6/01/2025 Date:

PROJECT DUNALLEY HOUSE

DATE

TITLE REF

Work in Progress1/02/2025

SITE INFORMATION

ADDRESS 41 BAY STREET, DUNALLEY TAS 7177 OWNER/CLIENT **ROB & DONNA SAUNDERS**

77611/3 MUNICIPALITY SORELL

LOW DENSITY RESIDENTIAL ZONING

DESIGNER Sarah Wimmer 875803611 LICENCE NO

CONTACT sarah@thresholddesigns.com.au

LAND SIZE 1014 sqmm² BUILDING CLASSIFICATION WIND CLASSIFICATION N3 SOIL CLASSIFICATION H-1 CLIMATE ZONE

CORROSION ENVIRONMENT MODERATE

ALPINE AREA

OTHER HAZARDS BUSHFIRE PRONE AREA

INDEX OF DRAWINGS

ID	NAME	REV
	SITE SURVEY	02 - WIP
DA.01	SITE PLAN	02 - WIP
DA.02	FLOOR PLAN	02 - WIP
DA.03	ROOF PLAN	02 - WIP
DA.04	ELEVATIONS	02 - WIP
DA.05	SHED	02 - WIP







GENERAL NOTES

ALL WORK SHALL BE IN ACCORDANCE AND COMPLY WITH THE RELEVANT AND CURRENT BUILDING CODE OF AUSTRALIA, COUNCIL BY-LAWS, AUSTRALIAN STANDARDS, CURRENT WORKPLACE STANDARDS AND CODES OF PRACTICE AND ALL APPROVAL CONDITIONS SPECIFIC TO THIS PROJECT.

ALL DIMENSIONS AND LEVELS TO BE VERIFIED ON SITE PRIOR TO COMMENCING CONSTRUCTION.

DO NOT SCALE FROM THIS DRAWING.

THE CONTRACTOR IS TO CONFIRM ON SITE ALL LEVELS, DATUMS, AND DIMENSIONS IN RELATION TO THE DRAWINGS AND THE SITE BEFORE PROCEEDING WITH WORKS

ENSURE THAT THIS DRAWING AND ANY ACCOMPANYING DETAILS AND/OR SPECIFICATIONS HAVE BEEN STAMPED AS 'APPROVED' BY THE RELEVANT LOCAL

ALL DISCREPANCIES TO BE REPORTED TO THE DESIGNER FOR INSTRUCTION

THE PROPRIETOR IS TO ENSURE THAT ANY "CONDITIONS OF APPROVAL" ISSUED BY THE BUILDING SURVEYOR, RELEVANT COUNCIL AND OTHER STATUTORY AUTHORITIES ARE PASSED ONTO THE CONTRACTOR BEFORE CONSTRUCTION

ANY ALTERATION TO THE CONSTRUCTION AND/OR MATERIALSINDICATED IN THESE DRAWINGS IS TO BE APPROVED BY THE DESIGNER, THE ENGINEER, THE BUILDING SURVEYOR, AND THE PROPRIETOR BEFORE PROCEEDING WITH THE


THE STRUCTURAL ENGINEER SHALL ENSURE THAT, AS FAR AS REASONABLY PRACTICABLE, THE BUILDING WORKS ARE STRUCTURALLY SOUND AND FIT-FOR-PURPOSE.


BUILDING WORK SHALL:

a) NOT CAUSE A NUISANCE TO BECOME A RISK OR THREAT TO PUBLIC HEALTH,

b) NOT ADVERSELY AFFECT AN OWNER, OCCUPIER, OR USER OF AN ADJOINING

ALL CONTRACTORS MUST CARRY OUT WORKS IN ACCORDANCE WITH CURRENT HEALTH AND SAFETY LEGISLATION AND BEST PRACTICE INCLUDING PREPARATION OF A CONSTRUCTION SAFETY MANAGEMENT PLAN

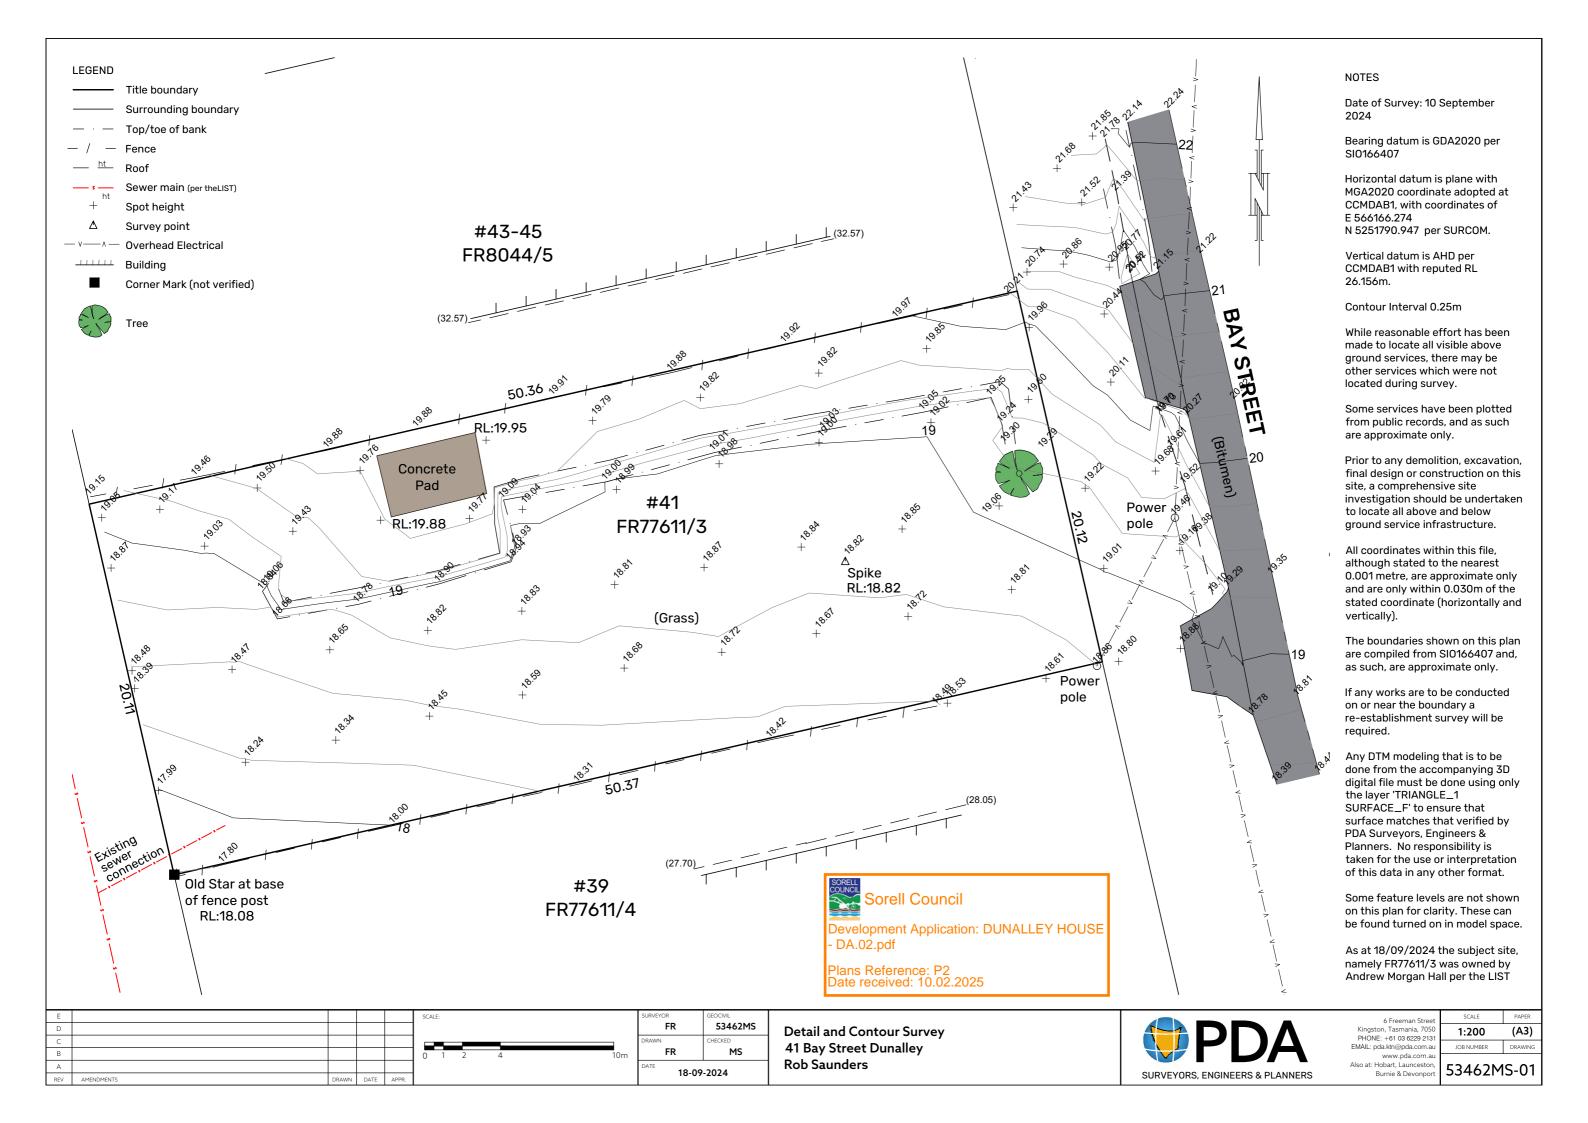

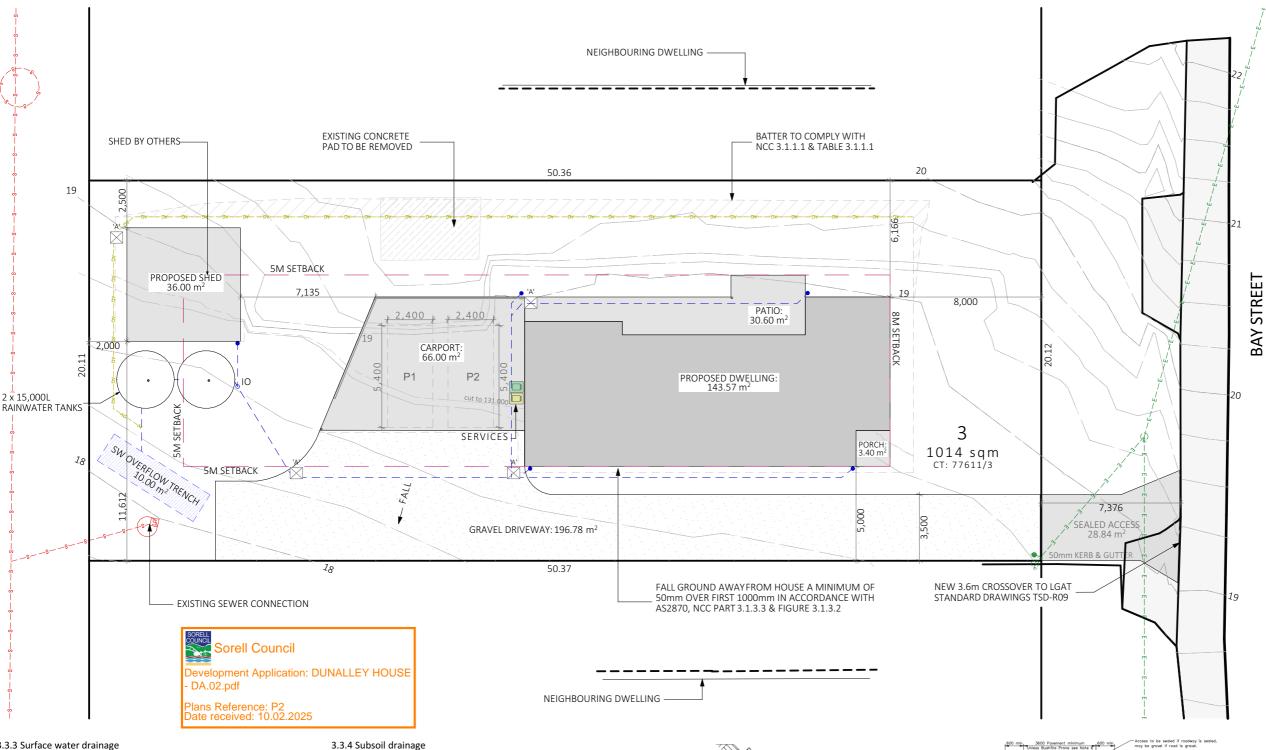

3.3.3 Surface water drainage

Surface water must be diverted away from a Class 1 building as follows: (a) Slab-on-ground — finished ground level adjacent to a building: the external finished surface surrounding the slab must be drained to move surface water away from the building and graded to give a slope of not less than:

(i) 25 mm over the first 1 m from the building

(A) in low rainfall intensity areas for surfaces that are reasonably impermeable (such as concrete or clay paving); or (B) for any reasonably impermeable surface that forms part of an access path or ramp provided for the purposes of Clauses 1.1(2) or (4)(c) of the ABCB Standard for Livable Housing Design; or (ii) 50 mm over the first 1 m from the building in any other case.

(b) Slab-on-ground — finished slab heights: the height of the slab-on-

- ground above external finished surfaces must be not less than —
 (i) 100 mm above the finished ground level in low rainfall intensity
- areas or sandy, well-drained areas; or (ii) 50 mm above impermeable (paved or concrete) areas that slope away from the building in accordance with (a); or (iii) 150 mm in any other case.

Where a subsoil drainage system is installed to divert subsurface water away from the area beneath a building, the subsoil drain must: (a) be graded with a uniform fall of not less than 1:300; and

(b) discharge into an external silt pit or sump with—
(i) the level of discharge from the silt pit or sump into an

impervious drainage line not less than 50 mm below the invert level of the inlet (see Figure 3.3.4); and (ii) provision for cleaning and maintenance.

3.3.5 Stormwater drainage

Where a stormwater drainage system is installed, it must comply with the

- (a) The position and manner of discharge of the stormwater drainage system must be to the satisfaction of the appropriate authority. (b) The stormwater drainage system must be designed so that any overflow during heavy rain periods is prevented from flowing back into the building.
- (c) Cover to stormwater drains: the cover to 90 mm Class 6 UPVC stormwater drains installed underground must be not less than:
 - (i) under soil: 100 mm; or
 - (ii) under paved or concrete areas: 50 mm; or (iii) under areas subject to light vehicle traffic:
 - reinforced concrete: 75 mm; or
 - paved: 100 mm.

Pervious backfill Rock Ag. drain @ 400 min.

TYPICAL AG. DRAIN DETAIL (≥1800 FROM HOUSE)

TSD-R02-v4

DUNALLEY HOUSE ROB & DONNA SAUNDERS

CROSS SECTION

DRIVEWAY PROFILE

DESCRIPTION: PROJECT ADDRESS:

41 BAY STREET, DUNALLEY TAS 7177

SITE NOTES

CONTOUR INTERVALS @ 0.25m. SITE LEVELS ARE APPROX ONLY. PLANS TO BE READ IN CONJUNCTION WITH THE CONTOUR AND DETAIL SURVEY 13286 UNDERTAKEN BY PDA ON 18/09/2024.

ALL SITE LEVELS TO BE CONFIRMED BY CONTRACTOR PRIOR TO CONSTRUCTION. EXTENT OF SITE CUT & RETAINING TO BE DETERMINED ON SITE. RL'S PROVIDED FOR FFL'S OF PROPOSED DWELLING & ASSOCIATED STRUCTURES ARE INDICATIVE ONLY & SHOULD BE DETERMINED ONSITE PRIOR TO CONSTRUCTION.

ALL WORKS TO COMPLY WITH THE NCC & AUSTRALIAN STANDARDS.

MIN SET DOWN FROM FFL 150MM. GROUND TO FALL AWAYFROM BUILDING IN ALL DIRECTIONS.

ALL ELEMENTS OF CONSTRUCTION INCLUDING FOOTINGS, DRAINAGE PROVISIONS, GUTTERS & DOWNPIPES ARE TO REMAIN ENTIRELY WITHIN THE PROPERTY BOUNDARIES.

SW PITS ARE INDICATIVE. LOCATION MAY VARY DEPENDING ON SITE CONDITIONS.

DOWNPIPES TO BE CONNECTED INTO COUNCIL STORMWARTER/WATER TANK AS SOON AS ROOF IS INSTALLED.

SITE PREPARATION

SITE PREPARATION TO COMPLY WITH 3.1.1 OF THE NCC AND AS3798.

FARTHWORKS

ALL SITE EARTHWORKS TO BE IN ACCORDANCE WITH 3.1.1 OF THE NCC AND AS3798.

EXCAVATETHE SITE TO REQUIRED LEVELS. EXTENT OF SITE CUT, FILL & RETAINING TO BE DETERMINED ON SITE, NOT TO EXCEED MORE THAN 1m AS PER PLANNING SCHEME REQUIREMENTS.

SLOPE GROUND AWAY FROM THE HOUSE/SLAB AT A SLOPE OF NOT LESS THAN 50mm OVER 1000mm DRAINAGE TO COMPLY WITH NCC PART 3.1.2.

DRIVEWAY & PARKINGDRIVE TO BE SUITABLY DRAINED AWAY FROM DWELLING TO SW PITS.

CAR PARKING TO AS 2890.1:2004, USER CLASS 1A.

SHED BY OTHERS

KEY ---- STORMWATER ---- SEWER MAIN **WATER ΜΔΙΝ** POWERLINE 450m² STORMWATER PIT

BUILDING AREAS: SITE AREA

PROPOSED DWELLING PROPOSED PATIO/PORCH PROPOSED SHED PROPOSED CARPORT	143.57 m ² 33.60 m ² 36.0 m ²
TOTAL FOOTPRINT	279.17 m ²
SITE COVERAGE	27%

1014 sqm m²

1/02/2025

DRAWING TITLE SITE PLAN

DA.01

DRAWING ID SCALE 1:200 @ A3




THRESHOLD BUILDING DESIGN 1 Longmans Road, Margate 7054 Drawings to be read in conjunction with specification by the author and all drawings and documents by engineers and subconsultants referred to in these plans. Contractors are to verify all dimensions on site before commencing any work or producing shop drawings. DO NOT SCALE FROM DRAWINGS. These drawings are protected by the laws of copyright and may not be provided or controlled without the mitter. ALL DISCREPANCIES TO BE BROUGHT TO THE ATTENTION OF THE AUTHOR

RFV ISSUF DATE 3/01/2025 01 DA Work in 02- WIP DA Progress

CLIENT CONTACT

sarah@thresholddesigns.com.au

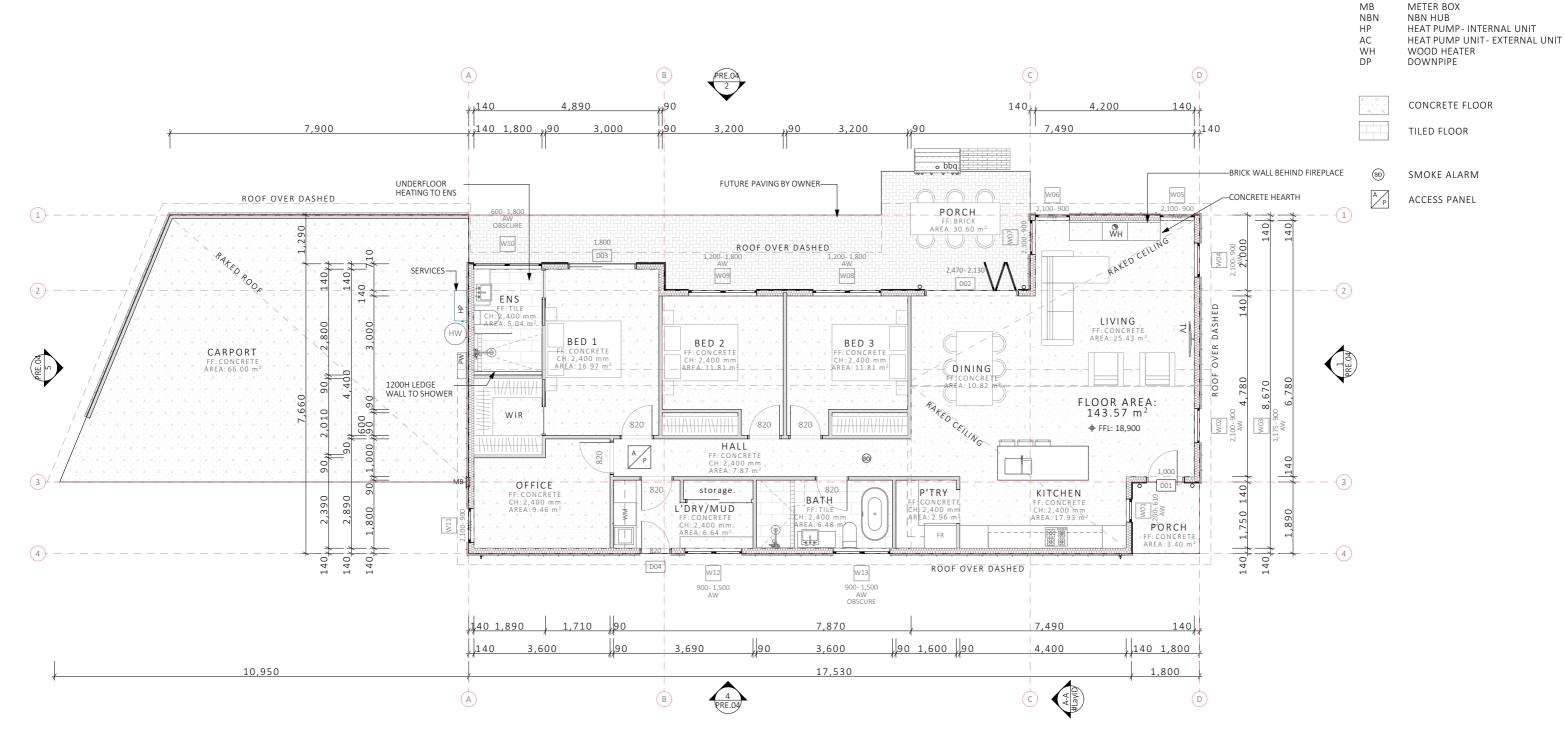



NOT FOR CONSTRUCTION


THRESHOLD BUILDING DESIGN **THRESHOLD** BUILDING DESIGN ___

Drawings to be read in conjunction with specification by the author and all drawings and documents by engineers and subconsultants referred to in these plans. Contractors are to verify all dimensions on site before commencing any work or producing shop drawings. DO NOT SCALE FROM DRAWINGS. These drawings are protected by the laws of copyright and may not be copied or reproduced without the written permission of the auth ALL DISCREPANCIES TO BE BROUGHT TO THE ATTENTION OF THE AUTHOR

REV 01 ISSUE DATE 3/01/2025 DA Work in 02- WIP DA Progress

DESCRIPTION: CLIENT: CONTACT:

DUNALLEY HOUSE PROJECT ADDRESS: 41 BAY STREET, DUNALLEY TAS 7177 **ROB & DONNA SAUNDERS** sarah@thresholddesigns.com.au

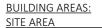

LEGEND:

FW

SD СН

FFL

HWC PH

AWNING WINDOW FIXED WINDOW

FINISHED FLOOR LEVEL

HOT WATER CYLINDER PANEL HEATER

SLIDING DOOR

CEILING HEIGHT

PROPOSED DWELLING 143.57 m² PROPOSED PATIO/PORCH 33.60 m² 36.0 m^2 PROPOSED SHED PROPOSED CARPORT 66.0 m² 279.17 m²

TOTAL FOOTPRINT SITE COVERAGE


DRAWING TITLE FLOOR PLAN

DRAWING ID SCALE 1:100 @ A3 1/02/2025 DA.02

1014 sqm m²

27%

1 Longmans Road, Margate 7054 0410 206 415 sarah@thresholddesigns.com.au

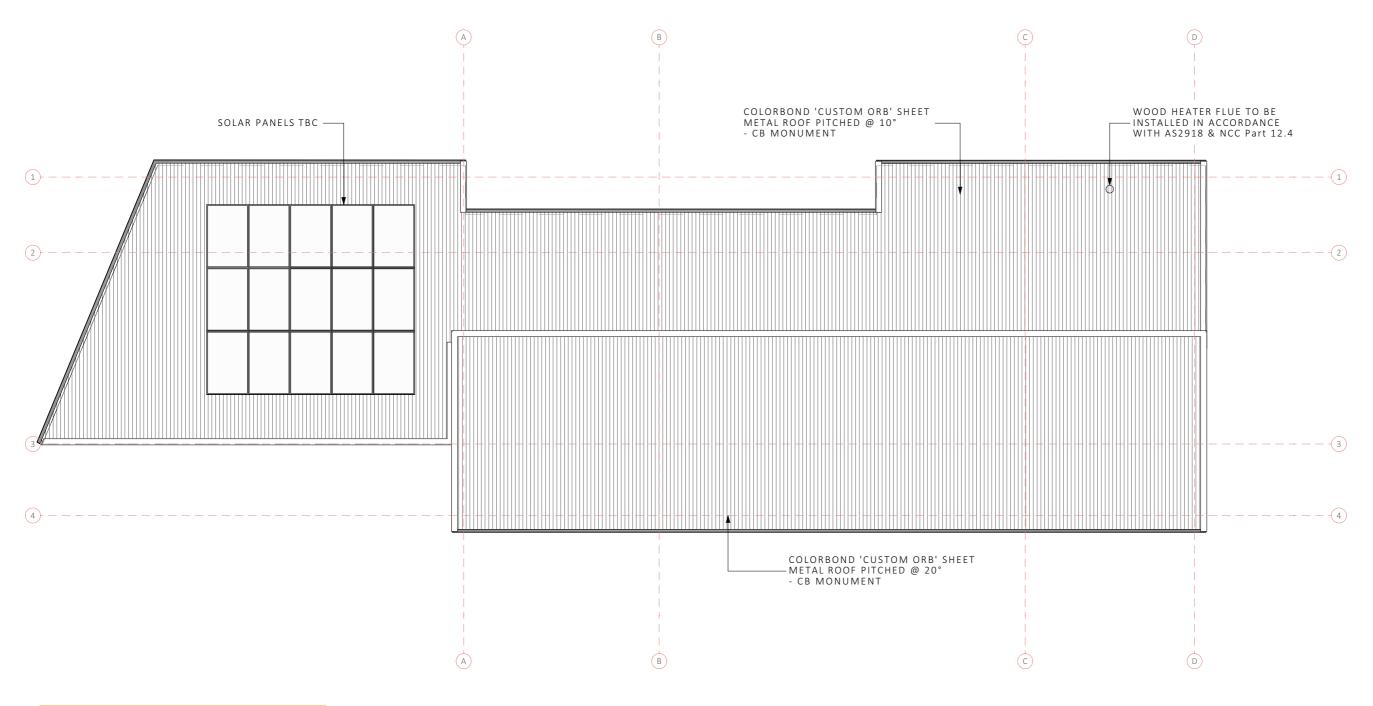



Development Application: DUNALLEY HOUSE - DA.02.pdf

Plans Reference: P2 Date received: 10.02.2025

ROOF PLAN

NOT FOR CONSTRUCTION

THRESHOLD BUILDING DESIGN THRESHOLD 1 Longmans Road, Margate 7054 0410 206 415 BUILDING DESIGN ___ sarah@thresholddesigns.com.au

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REV 01 ISSUE DATE 3/01/2025 DA Work in Progress 02- WIP DA

DESCRIPTION: CLIENT:

CONTACT:


DUNALLEY HOUSE PROJECT ADDRESS: 41 BAY STREET, DUNALLEY TAS 7177 ROB & DONNA SAUNDERS sarah@thresholddesigns.com.au





BUILDING ARE	EAS:		
SITE AREA			1014 sqm m ²
PROPOSED DV PROPOSED PA PROPOSED SH PROPOSED CA	TIO/PORC	CH	143.57 m ² 33.60 m ² 36.0 m ² 66.0 m ²
TOTAL FOOTPI	RINT		279.17 m ²
SITE COVERAG	ΘE		27%
DRAWING TITL ROOF PLAN	_		
DRAWING ID	SCALE		DATE
DA.03	1:100	@ A3	1/02/202

<u>NOTE</u>

CLEARANCES BETWEEN CLADDING AND GROUND SHALL COMPLY WITH 3.5.4.7 OF THE CURRENT N.C.C AND SHALL BE A MINIMUM CLEARANCE OF: - 100MM IN LOW RAINFALL INTENSITY AREAS OR SANDY, WELL-DRAINED AREAS;

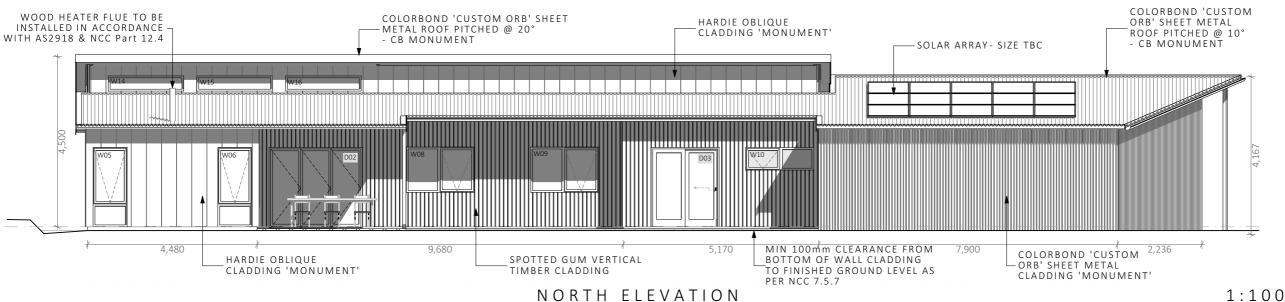

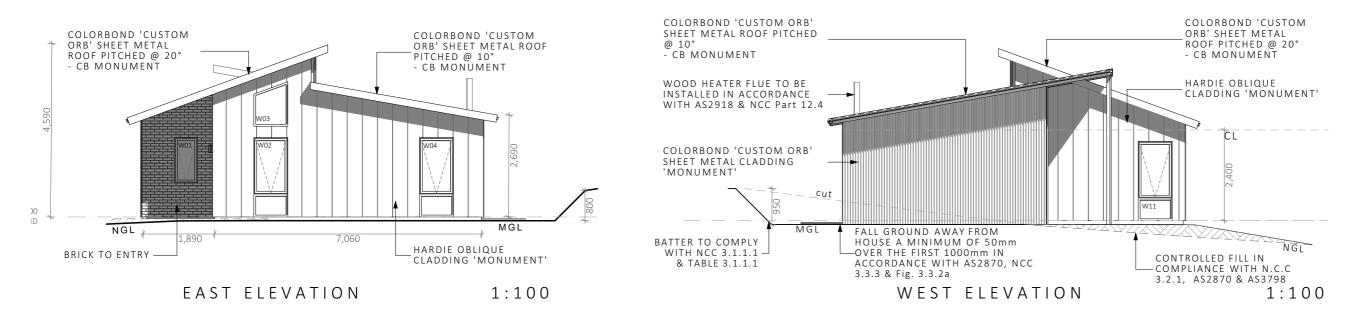

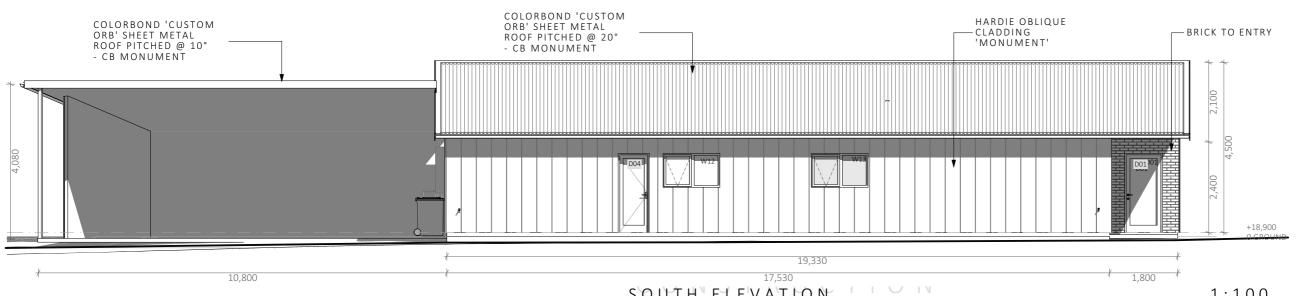

orell Council velopment Application: DUNALLEY HOUSE Plans Reference: P2 Date received: 10.02.2025

SOUTH ELEVATION

1:100

DRAWING TITLE

ELEVATIONS DRAWING ID SCALE 1:100 @ A3 DA.04 1/02/2025

THRESHOLD BUILDING DESIGN THRESHŌLD 1 Longmans Road, Margate 7054 BUILDING DESIGN ___

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REV ISSUE DATE 3/01/2025 01 DA Work in 02- WIP DA Progress

DESCRIPTION: **DUNALLEY HOUSE** PROJECT ADDRESS: 41 BAY STREET, DUNALLEY TAS 7177 CLIENT: **ROB & DONNA SAUNDERS** CONTACT: sarah@thresholddesigns.com.au

6.6m _ 3.62 m (max) (Mirror View) 6.6m 11° 6m Right End Left End - 2.00m 2.4m

NOT FOR CONSTRUCTION



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REV 01 ISSUE DA DATE 3/01/2025 Work in Progress 02- WIP DA

Side

DESCRIPTION: CLIENT:

CONTACT:

DUNALLEY HOUSE PROJECT ADDRESS: 41 BAY STREET, DUNALLEY TAS 7177 **ROB & DONNA SAUNDERS** sarah@thresholddesigns.com.au

Sorell Council

SHED BY OTHERS

SANDY, WELL-DRAINED AREAS;

CLEARANCES BETWEEN CLADDING AND GROUND SHALL COMPLY WITH 3.5.4.7 OF THE CURRENT N.C.C AND SHALL BE A MINIMUM CLEARANCE OF: - 100MM IN LOW RAINFALL INTENSITY AREAS OR

<u>NOTE</u>

Development Application: DUNALLEY HOUSE

- DA.02.pdf

Plans Reference: P2 Date received: 10.02.2025

DRAWING TITLE

SHED

DRAWING ID SCALE @ A3 1/02/2025 DA.05