

NOTICE OF PROPOSED DEVELOPMENT

Notice is hereby given that an application has been made for planning approval for the following development:

SITE: 22 Friendship Drive, Sorell

PROPOSED DEVELOPMENT:

DWELLING

The relevant plans and documents can be inspected at the Council Offices at 47 Cole Street, Sorell during normal office hours, or the plans may be viewed on Council's website at www.sorell.tas.gov.au until **Tuesday 5th November 2024.**

Any person may make representation in relation to the proposal by letter or electronic mail (<u>sorell.council@sorell.tas.gov.au</u>) addressed to the General Manager. Representations must be received no later than **Tuesday 5th November 2024**.

APPLICANT: Wilson Homes Pty Ltd

APPLICATION NO: DA 2024 /245 - 1
DATE: 17 October 2024

Part B: Please note that Part B of this form is publicly exhibited.

Full description of Proposal:	Use:				
5 5 p 5 5 5	Development:				
	Large or complex proposals should be described in a letter or planning report.				
	Lurge of complex proposuls s	nould be describ	ed in a letter of planning report.		
Design and cons	struction cost of proposal:	\$			
Is all, or some th	ne work already constructed:	No: □	Yes: □		
Location of					
proposed					
works:			stcode:		
	Certificate of Title(s) Volum	e:	Folio:		
Current Use of Site					
Current Owner/s:	Name(s)				
Is the Property of Register?	on the Tasmanian Heritage	No: ☐ Yes: [If yes, please provide written advice from Heritage Tasmania		
Is the proposal than one stage?	to be carried out in more	No: ☐ Yes: [If yes, please clearly describe in plans		
Have any poten been undertake	tially contaminating uses n on the site?	No: ☐ Yes: [If yes, please complete the Additional Information for Non-Residential Use		
Is any vegetation	n proposed to be removed?	No: ☐ Yes: [If yes, please ensure plans clearly show area to be impacted		
Does the propose administered or or Council?	sal involve land owned by either the Crown	No: ☐ Yes: [If yes, please complete the Council or Crown land section on page 3		
		•	uncil to the front boundary please		
-	chicular Crossing (and Associa		plication form		
nttps://www.so	rell.tas.gov.au/services/egine	<u>ering/</u>			

Sorell Council

Development Application: Development
Application - 22 Friendship Drive, Sorell - P1.pdf

Plans Reference:P1
Date Received:4/10/2024

Declarations and acknowledgements

- I/we confirm that the application does not contradict any easement, covenant or restriction specified in the Certificate of Title, Schedule of Easements or Part 5 Agreement for the land.
- I/we consent to Council employees or consultants entering the site and have arranged permission and/or access for Council's representatives to enter the land at any time during normal business hours.
- I/we authorise the provision of a copy of any documents relating to this application to any person for the purposes of assessment or public consultation and have permission of the copyright owner for such copies.
- I/we declare that, in accordance with s52(1) of the Land Use Planning and Approvals Act 1993, that I have notified the owner(s) of the intention to make this application.
- I/we declare that the information in this application is true and correct.

Details of how the Council manages personal information and how you can request access or corrections to it is outlined in Council's Privacy Policy available on the Council website.

- I/we acknowledge that the documentation submitted in support of my application will become a public record held by Council and may be reproduced by Council in both electronic and hard copy format in order to facilitate the assessment process, for display purposes during public exhibition, and to fulfil its statutory obligations. I further acknowledge that following determination of my application, Council will store documentation relating to my application in electronic format only.
- Where the General Manager's consent is also required under s.14 of the *Urban Drainage Act 2013*, by making this application I/we also apply for that consent.

Crown or General Manager Land Owner Consent

If the land that is the subject of this application is owned or administered by either the Crown or Sorell Council, the consent of the relevant Minister or the Council General Manager whichever is applicable, must be included here. This consent should be completed and signed by either the General Manager, the Minister, or a delegate (as specified in s52 (1D-1G) of the *Land Use Planning and Approvals Act 1993*).

Please note:

- If General Manager consent if required, please first complete the General Manager consent application form available on our website www.sorell.tas.gov.au
- If the application involves Crown land you will also need a letter of consent.
- Any consent is for the purposes of making this application only and is not consent to undertaken work or take any other action with respect to the proposed use or development.

1		being responsible for the
administration of land at		
declare that I have given permiss	Sorell Council Development Application: Development Application - 22 Friendship Drive, Sorell - P1.pdf Plens Reference:P1 Date Received:4/10/2024	
Signature of General Manager, Minister or Delegate:	Signature:	Date:

AS2870:2011 SITE ASSESSMENT

22 Friendship Drive Sorell August 2024

Wilson Homes Reference: 714091







GEO-ENVIRONMENTAL

SOLUTIONS



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Investigation Details

Client: Wilson Homes

Site Address: 22 Friendship Drive, Sorell

Date of Inspection: 08/08/2024

Proposed Works: New house

Investigation Method: Geoprobe 540UD - Direct Push

Inspected by: C. Cooper

Site Details

Certificate of Title (CT): 184600/167

Title Area: Approx. 505.3 m²

Applicable Planning Overlays: Bushfire-prone areas, Airport obstacle limitation area

Slope & Aspect: 4° S facing slope

Vegetation: Grass & Weeds

Background Information

Geology Map: MRT 1:25000

Geological Unit: Tertiary Basalt

Climate: Annual rainfall 400mm

Water Connection: Mains

Sewer Connection: Serviced-Mains

Testing and Classification: AS2870:2011, AS1726:2017 & AS4055:2021









Investigation

A number of bore holes were completed to identify the distribution and variation of the soil materials at the site, bore hole locations are indicated on the site plan. See soil profile conditions presented below. Tests were conducted across the site to obtain bearing capacities of the material at the time of this investigation.

Soil Profile Summary

BH 1 Depth (m)	BH 2 Depth (m)	USCS	Description
	0.00-0.10	IVIL	Clayey SILT: low plasticity, dark brown, moist, medium dense,
0.00-0.40	0.10-0.50		Silty CLAY: trace of gravels, high plasticity, grey, brown, slightly moist, stiff,
0.40-0.60		l GC	Clayey GRAVEL: grey, yellow, slightly moist, dense, refusal.

Site Notes

Soils onsite have developed from Tertiary basalt, the clay fraction is likely to show moderate ground surface movement with moisture fluctuations.

Site Classification

The site has been assessed and classified in accordance with AS2870:2011 "Residential Slabs and Footings".

The site has been classified as:

Class M

Y's range: **20-40mm**

Notes: This is a moderately reactive site





Wind Loading Classification

According to "AS4055:2021 - Wind Loads for Housing" the house site is classified below:

Wind Classification:	N2
Region:	Α
Terrain Category:	2.5
Shielding Classification:	NS
Topographic Classification:	T1
Wind Classification:	N2
Design Wind Gust Speed – m/s (V _{h,u}):	40

Construction Notes & Recommendations

The site has been classified as **Class M** - Moderately reactive clay or silt site, which may experience moderate ground movement from moisture changes.

It is recommended the foundations be placed on the underlying bedrock to minimise the potential for significant foundation movement.

All earthworks on site must comply with AS3798:2012, and I further recommend that consideration be given to drainage and sediment control on site during and after construction. Care should also be taken to ensure there is adequate drainage in the construction area to avoid the potential for weak bearing and foundation settlement associated with excessive soil moisture.

I also recommend that during construction that I and/or the design engineer be notified of any major variation to the foundation conditions as predicted in this report.

Dr John Paul Cumming B.Agr.Sc (hons) PhD CPSS GAICD Director





Explanatory Notes

1 Scope of Works

The methods of description and classification of soils used in this report are based largely on Australian Standard 1726 – Geotechnical Site Investigations (AS1726:2017), with reference to Australian Standard 1289 – Methods for testing soils for engineering purposes (AS1289), for eventual Site Classification according to Australian Standard 2870 (AS2870:2011) – Residential Slabs and Footings and Australian Standard 1547 (AS1547:2012) On-site domestic wastewater management.

1.1 Site Classification AS2870:2011

Site classification with reference to the above Australian Standards are based on site reactivity.

Class	Foundation Conditions	Characteristic Surface Movement
Α	Most sand and rock sites with little or no ground movement from moisture changes.	0mm
S	Slightly reactive clay sites, which may experience only slight ground movement from moisture changes.	0 – 20mm
М	Moderately reactive clay or silt sites, which may experience moderate ground movement from moisture changes.	20 – 40mm
H-1	Highly reactive clay sites, which may experience high ground movement from moisture changes.	40 – 60mm
H-2	Highly reactive clay sites, which may experience very high ground movement from moisture changes.	60 – 75mm
Е	Extremely reactive sites, which may experience extreme ground movement from moisture changes.	>75mm

Note: Soils where foundation performance may be significantly affected by factors other than reactive soil movement are classified as **Class P**.

A site is classified as Class P when:

- The bearing capacity of the soil profile in the foundation zone is generally less than 100kpa
- If excessive foundation settlement may occur due to loading on the foundation.
- The site contains uncontrolled fill greater than 0.8m in depth for sandy sites and 0.4m in depth for other soil materials.
- The site is subject to mine subsistence, landslip, collapse activity or coastal erosion.
- The site is underlain by highly dispersive soils with significant potential for erosion
- If the site is subject to abnormal moisture conditions which can affect foundation performance









1.2 **Soil Characterisation**

This information explains the terms of phrase used within the soil description area of the report.

It includes terminology for cohesive and non-cohesive soils and includes information on how the Unified Soil Classification Scheme (USCS) codes are determined.

NON COHESIVE – SAND & GRAVEL					
Consistency Description Field Test		Dynamic Cone Penetrometer blows/100 mm			
Very loose (VL)	Easily penetrated with 13 mm reinforcing rod pushed by hand.	0 - 1			
Loose (L)	Easily penetrated with 13 mm reinforcing rod pushed by hand. Can be excavated with a spade; 50 mm wooden peg can be easily driven.	1 - 3			
Medium dense (MD)	Penetrated 300 mm with 13 mm reinforcing rod driven with 2 kg hammer, - hard shovelling.	3 - 8			
Dense (D)	Penetrated 300 mm with 13 mm reinforcing rod driven with 2 kg hammer, requires pick for excavation: 50 mm wooden peg hard to drive.	8 - 15			
Very dense (VD)	Penetrated only 25 - 50 mm with 13 mm reinforcing rod driven with 2 kg hammer.	>15			

COHESIVE - SILT & CLAY					
Consistency Description	Field Test	Indicative undrained shear strength kPa			
Very soft	Easily penetrated >40 mm by thumb. Exudes between thumb and fingers when squeezed in hand.	<12			
Soft	Easily penetrated 10 mm by thumb. Moulded by light finger pressure	>12 and <25			
Firm	Impression by thumb with moderate effort. Moulded by strong finger pressure	>25 and <50			
Stiff	Slight impression by thumb cannot be moulded with finger.	>50 and <100			
Very Stiff	Very tough. Readily indented by thumbnail.	>100 and <200			
Hard	Brittle. Indented with difficulty by thumbnail.	>200			









1.3 USCS Material Descriptions

Soils for engineering purposes are the unconsolidated materials above bedrock, they can be residual, alluvial, colluvial or aeolian in origin.

Majo	or Divisions	Particle size mm	USCS Group Symbol	Typical Names	Laboratory Classification						
Ê	BOULDERS	200			% <	0. <mark>0</mark> 75 mm (2)	Plasticity of fine fraction	$C_{ii} = \frac{D_{40}}{D_{10}}$	$C_i = \frac{(D_{io})^2}{(D_{io})(D_{io})}$	NOTES	
(mm)	COBBLES	17245	w s			507 - 30	x		c.	307	
than 0.075		63	GW	Well graded gravels and gravel-sand mixtures, little or no fines		0-5	8 	>4	Between 1 and 3	(1) Identify fines by the method give	
Sarger	GRAVELS (more than	coarse	GP	Poorly graded gravels and gravel-sand mixtures, little or no fines, uniform gravels	Divisions'	0-5	\$ 		comply with	for fine-grained	
NED SO	half of coarse	medium	GM	Silty gravels, gravel-sand-silt mixtures (1)	Major	12-50	Below 'A' line or PI<4	55			
COARSE GRAINED SOIL	fraction is larger than 2.36 mm)	6 fine 2.36	GC	Clayey gravels, gravel-sand- clay mixtures (1)	given in	12-50	Above 'A' line and PI>7	5		(2) Borderline	
8	SANDS	0 10 10 10 10 10 10 10 10 10 10 10 10 10	SW	Well graded sands and gravelly sands, little or no fines	he criteria	0-5	g <u>ere</u>	>6	Between 1 and 3	classifications occur when the percentage of fines (fraction	
than half of	(more than half of coarse fraction is smaller than 2.36 mm)	0.6	SP	Poorly graded sands and gravelly sands, little or no fines	of fractions according to the	0-5	8-		comply with	smaller than 0.075 mm size is greater than	
more tha		medium 0.2	SM	Silty sands, sand silt mixtures (1)	MB acco	12-50	Below 'A' line or PI<4	1920	223;	5% and less than 12%. Borderline classifications require the use of SP-SM, GW- GC.	
٥		fine 0.075	sc	Clayey sands, sand-clay mixtures (1)	of fraction	12-50	Above 'A' line and PI>7	1200	_		
man 0.075 mm	ML Inorganic sands, ro clayey fir sits with			Inorganic silts, very fine sands, rock flour, silty or clayey fine sands or clayey silts with slight plasticity	Tor classification of fine grained soils				ined soils		
smaller		000	CL	Inorganic clays of low to medium plasticity, gravelly clays, sandy clays, silty clays, lean clays	g 63 mm for	60			n or coarse gr	ained soils.	
SOILS			OL	Organic silts and clays of low plasticity	bussed	8				10.00	
GRAINED SOILS less than 63 mm is			МН	Inorganic silts, mic- aceous or diato-maceous fine sands or silts, elastic silts	gradation curve of material	Plastic Index (%)			4/	State Balting	
FINE of material le	SILTS & CLA (Liquid Limit :	6 & CLAYS d Limit >50%) CH Inorganic clays of high plasticity, fat clays	curve	220.00	15:35	30.00 A	MHRC	ot l			
			ОН	Organic silts and clays of high plasticity	adation	10	/04	M	8 CL		
(more than half	HIGHLY ORGANIC SOILS		PT	Peat and other highly organic soils	Use the gr	0	10 20	30 40 Liqu	se 60 uid Limit (%)	70 80 90 100	









Grain size analysis is performed by two processes depending on particle size. Sand silt and clay particles are assessed using a standardised hydrometer test, and coarse sand and larger is assessed through sieving by USCS certified sieves. For more detail see the following section.

Soil Classification	Particle Size
Clay	Less than 0.002mm
Silt	0.002 – 0.06mm
Fine/Medium Sand	0.06 – 2.0mm
Coarse Sand	2.0mm – 4.75mm
Gravel	4.75mm – 60.00mm

1.4 Bearing Capacities and DCP testing.

DCP and PSP weighted penetrometer tests – Dynamic Cone Penetrometer (DCP) and Perth Sand Penetrometer (PSP) tests are carried out by driving a rod into the ground with a falling weight hammer and measuring the blows for successive 100mm increments of penetration. Normally, there is a depth limitation of 1.2m but this may be extended in certain conditions by the use of extension rods. The methods for the two tests are quite similar.

- Dynamic Cone Penetrometer a 16mm rod with a 20mm diameter cone end is driven with a 9kg hammer dropping 510mm (AS 1289, Test 6.3.2).
- Perth Sand Penetrometer a 16mm diameter flat-ended rod is driven with a 9kg hammer, dropping 600mm (AS 1289 Test 6.3.3). This test was developed for testing the density of sands and is mainly used in granular soils and filling.

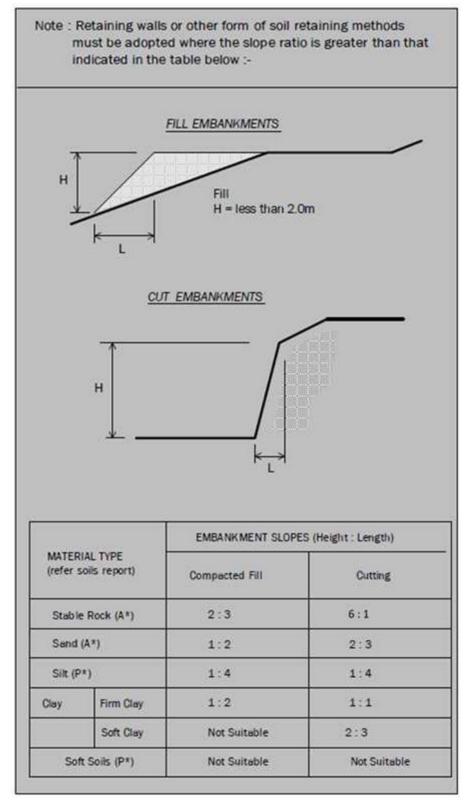
Site Anomalies – During construction GES will need to be notified of any major variation to the foundation conditions as predicted in this report.







1.5 Batter Angles for Embankments (Guide Only)







Glossary of Terms

Bearing Capacity – Maximum bearing pressure that can be sustained by the foundation from the proposed footing system under service loads which should avoid failure or excessive settlement.

Clay – (Mineral particles less than 0.002mm in diameter). Fine grained cohesive soil with plastic properties when wet. Also includes sandy clays, silty clays, and gravelly clays.

Dynamic Cone Penetrometer (DCP) – Field equipment used to determine underlying soil strength and therefore bearing capacity (kPa) by measuring the penetration of the device into the soil after each hammer blow.

Dispersive soil – A soil that has the ability to pass rapidly into suspension in water.

Footing – Construction which transfers the load from the building to the foundation.

Foundation – Ground which supports the building

Landslip – Foundation condition on a sloping site where downhill foundation movement or failure is a design consideration.

Qualified Engineer – A professional engineer with academic qualifications in geotechnical or structural engineering who also has extensive experience in the design of the footing systems for houses or similar structures.

Reactive Site – Site consisting of clay soil which swells on wetting and shrinks on drying by an amount that can damage buildings on light strip footings or unstiffened slabs. Includes sites classified as S, M, H-1, H-2 & E in accordance with AS2870-2011.

Sand – (Mineral particles greater than 0.02mm in diameter). Granular non-cohesive, non-plastic soil that may contain fines including silt or clay up to 15%.

Services – Means all underground services to the site including but not limited to power, telephone, sewerage, water & storm water.

Silt – (Mineral particles 0.002 – 0.02mm in diameter). Fine grained non-cohesive soil, non-plastic when wet. Often confers a silky smoothness of field texture, regularly includes clay and sand to form clayey silts, sandy silts and gravelly silts.

Site – The site title, as denoted by address, lot number, or Certificate of Title (CT) number, or Property Identification Number (PID).

Surface Movement (Ys) – Design movement (mm) at the surface of a reactive site caused by moisture changes.





Disclaimer

This Report has been prepared in accordance with the scope of services between Geo-Environmental Solutions Pty. Ltd. (GES) and the Client. To the best of GES's knowledge, the information presented herein represents the client's requirements at the time of printing of the Report. However, the passage of time, manifestation of latent conditions or impacts of future events may result in findings differing from that discussed in this Report. In preparing this Report, GES has relied upon data, surveys, analyses, designs, plans and other information provided by the Client and other individuals and organisations referenced herein. Except as otherwise stated in this Report, GES has not verified the accuracy or completeness of such data, surveys, analyses, designs, plans and other information.

The scope of this study does not allow for the review of every possible geotechnical parameter or the soil conditions over the whole area of the site. Soil and rock samples collected from the investigation area are assumed to be representative of the areas from where they were collected and not indicative of the entire site. The conclusions discussed within this report are based on observations and/or testing at these investigation points.

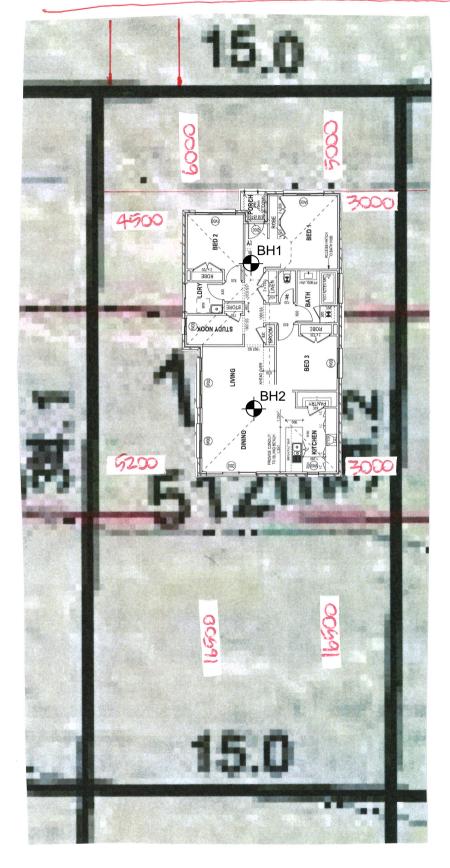
This report does not purport to provide legal advice. Readers of the report should engage professional legal practitioners for this purpose as required.

No responsibility is accepted for use of any part of this report in any other context or for any other purpose by third a party.



PRELIMINARY ESTIMATE PLAN

Road



Sorell Council

Development Application: Development
Application - 22 Friendship Drive, Sorell - P1.pd

Plans Reference:P1

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	DRAWING		DRAWN	
1		_	YYYY.MM.DD	

DD.	CLIENT: SOPHIE	R055	LOT N	167
-	ADDRESS	ESTATE	DP No	.:
-	SUBURB: SOREIL	POSTCODE: COUNCIL: TBA	GORELI	

HOUSE DESIGN: TARUA 13	HOUSE CODE:	
FACADE DESIGN: CLASSIC	FACADE CODE:	
SHEET TITLE: PRELIMINARY ESTIMATE SITING	SCALES:	SHEET No.: 1 / 1

DO NOT SCALE DRAWINGS. USE FIGURED DIMENSIONS ONLY. CHECK AND VERIFY DIMENSIONS AND LEVELS PRIOR TO THE COMMENCEMENT OF ANY WORK. ALL DISCREPANCIES TO BE REPORTED TO THE DRAFTING OFFICE.

File I gration: P.18 DraffingtCAD FilestArchiCAD Template A21 WH Template - resource

CERTIFICATE OF QUALIFIED PERSON – ASSESSABLE ITEM

Section 321

То	: Wilson Homes				Owner /Agent			C
	250 Murray Street				Address	Form	₁ 5	J
	Hobart]	70	00	Suburb/postcode			
Qualified pers	son details:							
Qualified person:	John-Paul Cumming							
Address:	29 Kirksway Place				Phone No:	03	6223	1839
	Battery Point]	70	04	Fax No:			
Licence No:	AO999 Email address	;: []	jcun	nming	@geosolutic	ns.net	t.au	
Qualifications and Insurance details:	Columba Tolocololiai Coli			Directo	iption from Column or's Determination - alified Persons for A	Certifica		
Speciality area of expertise:	AS2870-2011 Foundation Classification			Direct	ription from Column or's Determination alified Persons for .	- Certifica		
Details of wor	k:							
Address:	22 Friendship Drive]	Lot No:		
	Sorell		71	72	Certificate of	title No:	1846 67	00/1
The assessable item related to this certificate:	Classification of foundation C according to AS2870-2011	ond	ditio	ns	(description of th certified) Assessable item - a material; - a design - a form of col - a document - testing of a consystem or pl - an inspection - performed	includes nstruction componer umbing s	– nt, buildin ystem	J
Certificate det	tails:							
Certificate type:	Foundation Classification			Sch Dete Qua	scription from Colur edule 1 of the Direct ermination - Certific diffied Persons for essable Items n	ctor's		
This certificate is	in relation to the above assessable iter	m, a	at an	y stage	e, as part of - <i>(ti</i>	ck one)		
	building work, plumbing work	or p	olumk	oing ins	stallation or der	nolition	work [☒
II Council	or							

Plans Reference:P1 Date Received:4/10/2024 a building, temporary structure or plumbing installation: \Box

In issuing this certificate the following matters are relevant –

Documents: The attached soil report for the address detailed above in 'details of

work'

Relevant

calculations: Reference the above report.

References: AS2870:2011 residential slabs and footings

AS1726:2017 Geotechnical site investigations

CSIRO Building technology file - 18.

Substance of Certificate: (what it is that is being certified)

Site Classification consistent with AS2870-2011.

Scope and/or Limitations

The classification applies to the site as inspected and does not account for future alteration to foundation conditions as a result of earth works, drainage condition changes or variations in site maintenance.

I, John-Paul Cumming certify the matters described in this certificate.

Qualified person:

Signed:

Certificate No:

J10737

Date: 09/08/2024







TOTAL FLOOR AREAS

M.	AIN DWELLING, GROUND FLOOR	
	LIVING	116.85
	PORCH	1.71
		118.56 m²

AS & NCC COMPLIANCE


ALL CONSTRUCTION TO BE IN ACCORDANCE WITH NCC 2022 AND APPLICABLE AUSTRALIAN STANDARDS AT TIME OF APPROVAL.

- SLAB IN ACCORDANCE WITH AS 2870. REFER TO ENGINEERS DETAILS

- FOR ALL SLAB DETAILS.
- BRICK CONTROL JOINTS PROVIDED IN ACCORDANCE WITH NCC 2022. ALL STEEL FRAMING TO BE DESIGNED TO AS 4100-2020 OR AS/NZS
- INSULATION TO BE INSTALLED IN ACCORDANCE WITH NCC 2022 AND ALL APPLICABLE AUSTRALIAN STANDARDS.
- TERMITE PROTECTION IN ACCORDANCE WITH AS 3660 AND NCC 2022. GLAZING IN ACCORDANCE WITH AS 1288 AND NCC 2022.
- SMOKE ALARMS IN ACCORDANCE WITH AS 3786 AND NCC 2022.
 INTERNAL WATERPROOFING IN ACCORDANCE WITH NCC 2022. HOUSING PROVISIONS PART 10.2. EXTERNAL WATERPROOFING IN ACCORDANCE WITH AS 3740 AND AS
- 4654. WET AREA FLOORS TO FALL TO FLOOR WASTES AT MIN. 1:80 AND MAX.
- 1:50 GRADE (IF APPLICABLE). CONDENSATION MANAGEMENT IN ACCORDANCE WITH NCC 2019.
- BUILDING SEALING IN ACCORDANCE WITH NCC 2022. SERVICES IN ACCORDANCE WITH NCC 2022.
- EARTHWORKS IN ACCORDANCE WITH AS 3798-2007. EXTERNAL WALL WRAP (SARKING) IN ACCORDANCE WITH NCC 2022 (IF
- APPLICABLE).
 EXHAUST FANS DUCTED TO OUTSIDE AIR (IF APPLICABLE).

SITE SPECIFIC CONT	ROLS
CONTROL	DETAILS
ACID SULPHATE SOIL	NO
BIODIVERSITY	NO
BUILDING ENVELOPE	NO
BUSHFIRE	BAL-LOW
CLIMATE ZONE (NCC)	ZONE 7 - COOL TEMPERATE
DESIGN WIND CLASSIFICATION	N2 (NOT EXPOSED)
ESTATE/DEVELOPER GUIDELINES	NO
FLOOD OVERLAY	NO
HERITAGE	NO
LANDSLIP HAZARD	NO
MINIMUM FLOOR LEVEL	NO
NATURAL ASSET CODE	NO
NOISE ATTENUATION	NO
SALINE SOIL	NO
SHIELDING FACTOR	NS - NO SHIELDING
SITE CLASSIFICATION	M
SPECIFIC AREA PLAN OVERLAY	NO
TERRAIN CATEGORY	TC2.5
TOPOGRAPHIC CLASSIFICATION	T1
WATERWAY & COASTAL OVERLAY	NO
WIND REGION	A - NORMAL
WITHIN 1km CALM SALT WATER	NO
WITHIN 50km BREAKING SURF	6.60km
ZONING	GENERAL RESIDENTIAL
AIRPORT OBSTACLE LIMITATION	
AIRPORT NOISE EXPOSURE	

BUILDING CONTROLS	& COMPLIA	NCE
CONTROL	REQUIRED	PROPOSED
SETBACKS		
FRONT	MIN. 4,500mm	4,503mm
SIDE A	MIN. 1,500mm	3,020mm
SIDE B	MIN. 1,500mm	3,500mm
REAR	MIN. 1,500mm	14,650mm
BULK & SCALE		
SITE AREA	512m²	
SITE COVERAGE	MAX. 50%	23.16%
LANDSCAPE		
NO APPLICABLE CONTROLS		
EARTHWORKS		
CUT DEPTH	MAX. 2,000mm	775mm
FILL DEPTH	MAX. 1,000mm	592mm
ACCESS & AMENITY		
PARKING SPACES	MIN. 2 SPACES	2 SPACES

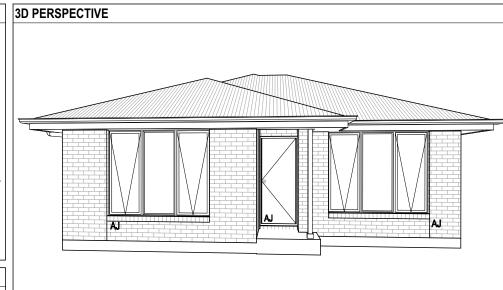

NOTE TO OWNER

THESE PLANS MAY FEATURE WORKS THAT ARE EXCLUDED FROM THE SCOPE OF WORKS WITH THE BUILDER, BUT THEY HAVE BEEN INCLUDED IN THESE DRAWINGS TO ASSIST IN THE OVERALL PLANNING AND ASSESSMENT OF THE BUILDING PROJECT. EXÁMPLES OF SOME REGULARLY EXCLUDED WORKS INCLUDE DRIVEWAYS, RETAINING WALLS, SOLAR PANEL SPACING AND SITE DRAINAGE, PLEASE REFER TO YOUR SCOPE OF WORKS AND COLOUR SELECTIONS DOCUMENTATION FOR DETAILS OF INCLUDED WORKS. SOME DETAILS ARE INDICATIVE ONLY FOR EXAMPLE FLOORING, TILING, BRICKWORK AND CLADDING (EXPANSION JOINTS, ORIENTATION AND LAYOUT) AND ARE SUBJECT TO CHANGE.



BUILDING INFORMATION	
GROUND FLOOR TOP OF WALL HEIGHT(S)	2445mm
NOTE: CEILING HEIGHT 45mm LOWER THA	N TOP OF WALL
ROOF PITCH (U.N.O.)	23.0°
ELECTRICITY SUPPLY	SINGLE PHASE
GAS SUPPLY	NONE
ROOF MATERIAL	SHEET METAL
ROOF COLOUR	N/A
WALL MATERIAL	BRICK VENEER
SLAB CLASSIFICATION	TBC

INSULAT	TION
ROOF	SARKING UNDER ROOFING
CEILING	R4.1 BATTS (EXCL. GARAGE, ALFRESCO & PATIO)
EXT. WALLS	R2.0 BATTS (EXCL. GARAGE) WALL WRAP TO ENTIRE HOUSE
INT. WALLS	R2.0 BATTS ADJACENT TO GARAGE AND AS PER PLAN
FLOOR	BIAX SLAB R0.60

THE OWNERS ACKNOWLEDGE THAT THESE CONTRACT PLANS MAY NOT REFLECT ALL THE SELECTIONS THAT HAVE BEEN MADE OR CHANGES REQUESTED. THE OWNERS AGREE THAT FOLLOWING THE COLOUR SELECTIONS VARIATION OR UPDATING OF PLANS, THEY WILL BE PROVIDED WITH CONSTRUCTION PLANS FOR SIGNATURE PRIOR TO COMMENCEMENT OF CONSTRUCTION.

SIGNATURE: DATE:

> **SUBJECT TO NCC 2022** (1 MAY 2023)

> > WATERPROOFING & PLUMBING PLAN ACCEPTANCE BY OWNER

SIGNATURE: DATE:

SIGNATURE: DATE:

PLEASE NOTE THAT VARIATIONS WILL NOT BE ACCEPTED AFTER THIS PLAN ACCEPTANCE HAS BEEN SIGNED

Sorell Council

ans Reference:P1 ate Received:4/10/2024

SHEET DATE DRAWN CHECK

ALL

2024.09.30

HMI

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WILSON	C
HOMES	(
ПППГЭ	

PRELIMINARY PLAN SET

PRELIMINARY PLAN SET - INITIAL ISSUE

AMENDMENT

No.

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	SPECIFICATION:		REVISION	DRAWN	CLIENT:		HOUSE DESIGN:		HOUSE CODE:	DO NOT SCALE DRAWINGS, USE	ı
1	DISCOVERY	1	DRAFT SALES PLAN - CT1	JOL 11/09/2024	SOPHIE ROSS		TARGA 13		H-WDCTRG10SA	FIGURED DIMENSIONS ONLY. CHECK AND VERIFY DIMENSIONS AND	.038
L	COPYRIGHT:	2	PRELIM PLAN - INITIAL ISSUE	HMI 30/09/2024			FACADE DESIGN:		1	LEVELS PRIOR TO THE COMMENCEMENT OF ANY WORK. ALL	
	© 2024				22 FRIENDSHIP DRI	VE, SORELL TAS 7172	CLASSIC		F-WDCTRG10CLASA	DISCREPANCIES TO BE REPORTED TO THE DRAFTING OFFICE.	Versic
					LOT / SECTION / CT:	COUNCIL:	SHEET TITLE:	SHEET No.:		714091	late '
	[167 / - / 184600	SORELL COUNCIL	COVER SHEET	1 / 13	1:100	14091	em


REFER TO SHEET 1 (COVER SHEET) FOR ALL BUILDING INFORMATION REGARDING: SUSTAINABILITY REQUIREMENTS SITE CLASSIFICATION GENERAL BUILDING INFORMATION


APPROX. CUT/FILL

EVEN C	UT & FILI	-
DIFFERENCE	0.46m³	1.04t
FILL	41.06m³	92.39t
CUT	40.60m³	91.35t

LOT SIZE: 512m² HOUSE (COVERED AREA) 118.56m² SITE COVERAGE: 23.15%

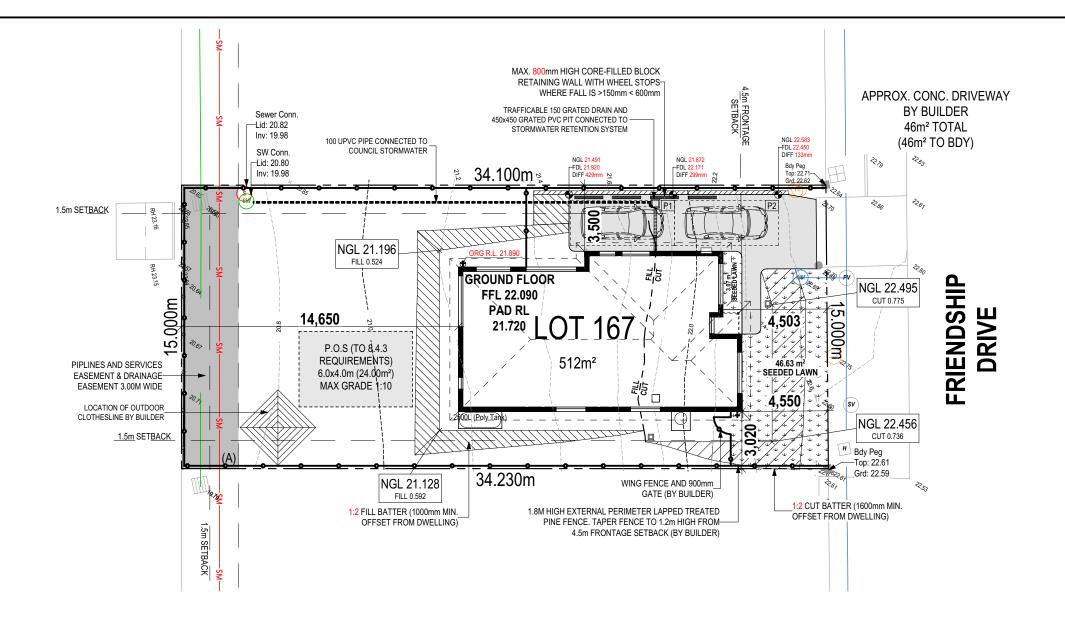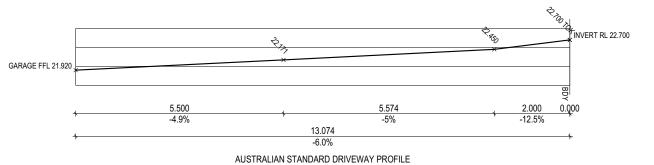DRY STACK WALLS <1m HIGH: ISLAND BLOCK & PAVING FREESTONE ECO RETAINING WALL INSTALLATION TO MANUFACTURER'S SPECIFICATION AND





DRIVEWAY DETAILS

SCALE: 1:100

orell Council pment Application: Development ation - 22 Friendship Drive, Sorell - P1.pdf **SUBJECT TO NCC 2022** (1 MAY 2023)

WATERPROOFING & PLUMBING

PLAN ACCEPTA	ANCE BY OWNER	ı
SIGNATURE:	DATE:	
SIGNATURE:	DATE:	
	TIONS WILL NOT BE ACCEPTED	ı

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			-					
SPECIFICATION:	REVISION	DRAW	٧N	CLIENT:	HOUSE DESIGN:		HOUSE CODE:	DO NOT SCALE DRAWINGS, USE
DISCOVERY				SOPHIE ROSS	TARGA 13		H-WDCTRG10SA	FIGURED DIMENSIONS ONLY. CHECK
DISCOVERT	1 DRAFT SALES PLAN - CT1	JOL 11/0	09/2024	SOPHIE ROSS	TARGA 13		n-wbcikgiosa	AND VERIFY DIMENSIONS AND
 COPYRIGHT:	2 PRELIM PLAN - INITIAL ISSUE	HMI 30/0	09/2024	ADDRESS:	FACADE DESIGN:		FACADE CODE:	LEVELS PRIOR TO THE COMMENCEMENT OF ANY WORK. ALL
	Z TICEMITERA MATERIALISA	111011 0070						DISCREPANCIES TO BE REPORTED
© 2024				22 FRIENDSHIP DRIVE, SORELL TAS 7172	CLASSIC		F-WDCTRG10CLASA	TO THE DRAFTING OFFICE.
				LOT / SECTION / CT: COUNCIL:	SHEET TITLE: SHE	EET No.:	SCALES:	= 4 4004
								714091
				167 / - / 184600 SORELL COUNCIL	SITE PLAN 2/	/ 13	1:200, 1:100	<i> </i> 1403

OWNER TO STABILISE THE SITE ON COMPLETION OF THE BUILD WITH TURF LAWNS, GRASS SEEDS, NATIVE GROUND COVERS AND/ OR MULCH SPREAD TO A DEPTH OF 75-100mm

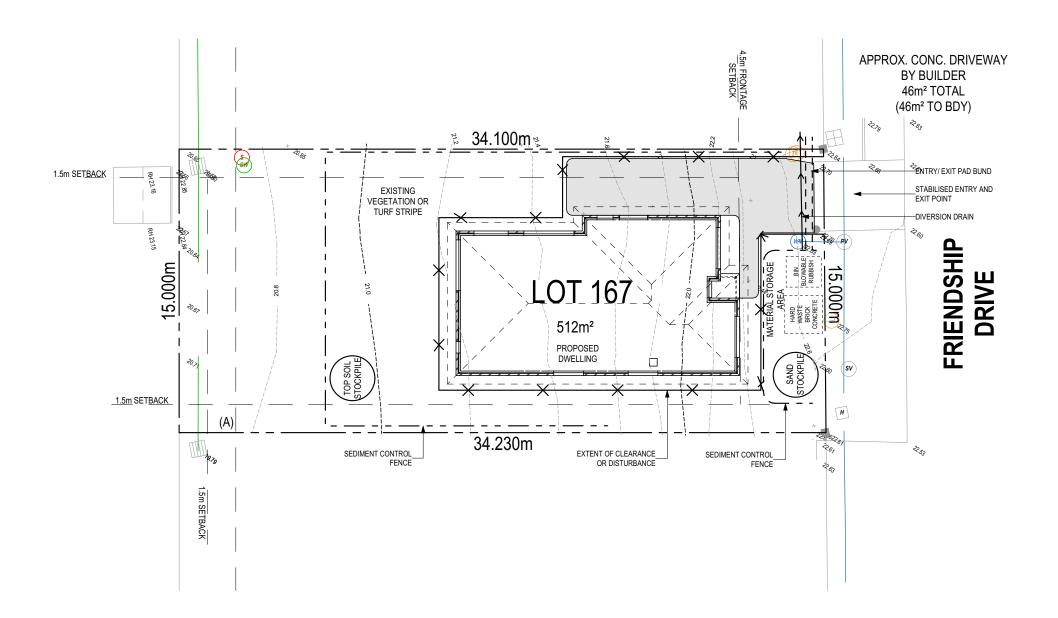
THE FOLLOWING IS A STANDARD APPROACH. SEDIMENT AND EROSION CONTROL MEASURES WILL BE REVIEWED PRIOR TO COMMENCING WORK AND INSTALLED BASED ON THE OUTCOME OF THAT REVIEW.

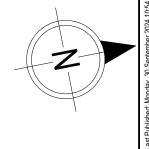
1. ALL EROSION AND SEDIMENT CONTROL STRUCTURES TO BE INSPECTED EACH WORKING DAY AND MAINTAINED IN GOOD WORKING ORDER.

- 2. ALL GROUND COVER VEGETATION OUTSIDE THE IMMEDIATE BUILDING AREA TO BE PRESERVED DURING THE BUILDING
- 3. ALL EROSION AND SEDIMENT CONROL MEASURES TO BE INSTALLED PRIOR TO COMMENCEMENT OF MAJOR EARTHWORKS.
- 4. STOCKPILES OF CLAYEY MATERIAL TO BE COVERED WITH AN IMPERVIOUS SHEET. 5. ROOF WATER DOWNPIPES TO BE CONNECTED TO THE PERMAMENT UNDERGROUND STORMWATER DRAINAGE SYSTEM AS SOON AS PRACTICAL AFTER

THE ROOF IS LAID.


6. DIVERSION DRAINS ARE TO BE CONNECTED TO A LEAGAL DISCHARGE POINT (COUNCIL STORMWATER SYSTEM, WATERCOURSE OR ROAD DRAIN). 7. SEDIMENT RETENTION TRAPS INSTALLED AROUND THE INLETS TO THE STORMWATER SYSTEM TO PREVENT SEDIMENT & OTHER DEBRIS BLOCKING THE DRAINS.







ALL RUNOFF AND SEDIMENT CONTROL STRUCTURES WILL BE INSPECTED EACH WORKING DAY AND MAINTAINED IN A FUNCTIONAL CONDITION.

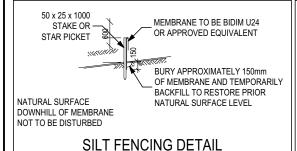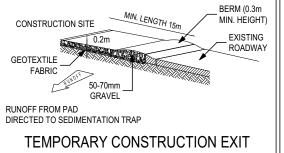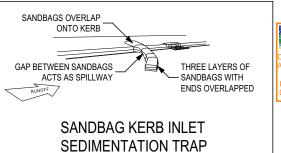ALL VEGETATION OUTSIDE THE BUILDING ZONE WILL BE MAINTAINED.







Sorell Council ans Reference:P1 ate Received:4/10/2024

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SUBJECT TO NCC 2022 (1 MAY 2023)

WATERPROOFING & PLUMBING

PLAN ACCEPTANCE BY OWNER SIGNATURE: DATE: SIGNATURE: DATE: PLEASE NOTE THAT VARIATIONS WILL NOT BE ACCEPTED AFTER THIS PLAN ACCEPTANCE HAS BEEN SIGNED

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	HOMES

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	ODEO(E)OATION:		D-1/12/2011		OLIFAIT:			HOUSE BEGION		HOUSE CORE	DO NOT COME DE MAINIOS LIGE	1
	SPECIFICATION:		REVISION	DRAWN	CLIENT:			HOUSE DESIGN:		HOUSE CODE:	DO NOT SCALE DRAWINGS, USE	i
1	DISCOVERY	1	DRAFT SALES PLAN - CT1	JOL 11/09/2024	SOPHIE ROSS			TARGA 13		H-WDCTRG10SA	FIGURED DIMENSIONS ONLY. CHECK AND VERIFY DIMENSIONS AND	038
н	COPYRIGHT:	2	PRELIM PLAN - INITIAL ISSUE	HMI 30/09/2024	ADDRESS:			FACADE DESIGN:		FACADE CODE:	LEVELS PRIOR TO THE COMMENCEMENT OF ANY WORK. ALL	1: 24
•	© 2024				22 FRIENDSHIP DRI	VE, SORELL TAS 7172		CLASSIC		F-WDCTRG10CLASA	DISCREPANCIES TO BE REPORTED TO THE DRAFTING OFFICE.	/ersior
					LOT / SECTION / CT:	COUNCIL:		SHEET TITLE:	SHEET No.:	SCALES:	744004	ate
					167 / - / 184600	SORELL COUNCIL		SOIL & WATER MANAGEMENT PLAN	3 / 13		714091	empl

ALL EXTERIOR SLABS TO BE GRADED BY CONCRETER TO ACHIEVE APPROX. 1:100 FALL TO OUTSIDE EDGE WITH MAXIMUM CROSSFALL OF 30mm OVER ENTIRE SLAB.

ANY PART OF THE FASCIA, GUTTERING OR DOWNPIPE THAT IS WITHIN 450mm OF ANY BOUNDARY IS TO BE NON-COMBUSTIBLE IN ACCORDANCE WITH NCC 2022

REFER TO SHEET 1 (COVER SHEET) FOR ALL BUILDING INFORMATION REGARDING SUSTAINABILITY REQUIREMENTS PORCH SITE CLASSIFICATION

GENERAL BUILDING INFORMATION ALL MECHANICAL VENTILATION TO BE DISCHARGED TO OUTDOOR AIR AS PER NCC 2022 REQUIREMENTS

FIRE RESISTANT PLASTERBOARD TO BE INSTALLED BEHIND COOKTOP

ALL GROUND FLOOR BULKHEAD AND SQUARE SET OPENING FRAMES TO BE 2155 ABOVE FFL UNLESS NOTED OTHERWISE

REFER TO WINDOW AND DOOR SCHEDULES FOR FULL DETAILS OF ALL WINDOWS AND DOORS. PLEASE NOTE WINDOW AND DOOR SIZES ARE BASED ON DEPOSIT STAGE AND MAY DIFFER SLIGHTLY TO THE SIZES NOMINATED IN THE SCOPE OF WORKS DUE TO MANUFACTURING CHANGES AT THE TIME OF CONSTRUCTION.

FINAL WINDOW AND EXTERIOR DOOR LOCATIONS MAY BE ADJUSTED ON SITE TO SUIT BRICKWORK GAUGE

UNLESS NOTED OTHERWISE ALL ROOMS ARE REFERENCED AS FOLLOWS:





HS / WS HOB SPOUT / WALL SPOUT FACE BRICK / COMMON BRICK

SOUND INSULATION

BRICK ARTICULATION JOINT SDP STANDARD DOWNPIPE

M

CDP CHARGED DOWNPIPE DENOTES DRAWER SIDE 3D

L.B.W LOAD BEARING WALL PB PLASTERBOARD

FC FIBRE CEMENT

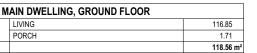
THIS DOOR OPENS FIRST

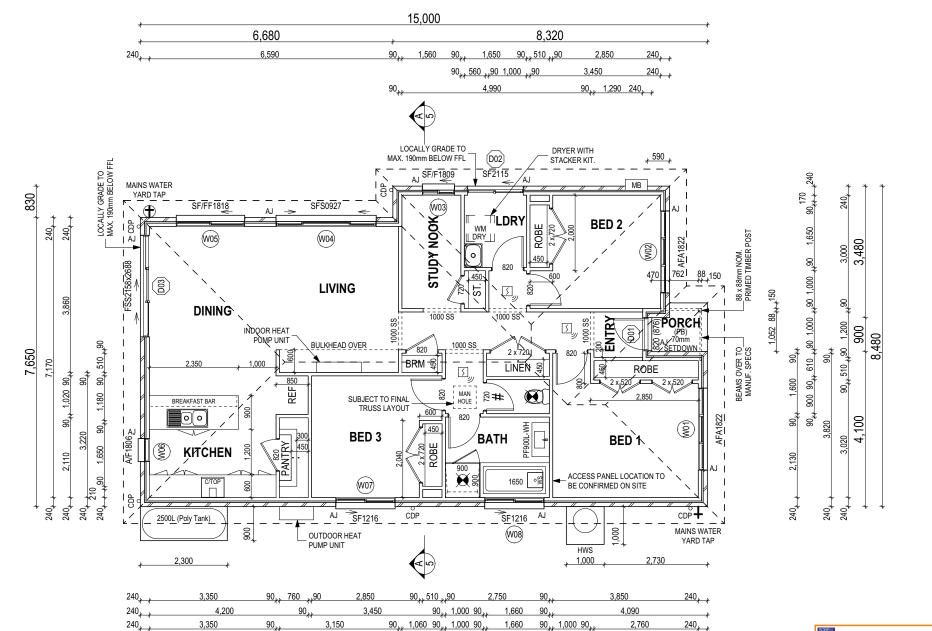
MECHANICAL VENTILATION

SMOKE ALARM LIFT OFF HINGE

+ WATER POINT

GAS BAYONET





Sorell Council

e Received:4/10/2024

SUBJECT TO NCC 2022 (1 MAY 2023)

WATERPROOFING & PLUMBING

PLAN ACCEPTANCE BY OWNER SIGNATURE: DATE:

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ALL DIMENSIONS ARE FRAME DIMENSIONS

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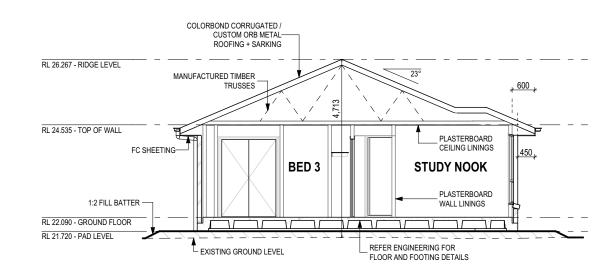
		IN ANT WAT REPRODUCE, COPT, MODIFF, USE OR TAKE ADVANTAGE OF THE DRAWING TO BOILD A HOUSE BASED ON THIS PLAN (WHETHER IN WHOLE OR IN PART) WITHOUT THE PRIOR WRITTEN CONSENT OF WILSON HOMES PTT CID.											
	SPECIFICATION:		REVISION	ſ	DRAWN	CLIENT:			HOUSE DESIGN:		HOUSE CODE:	DO NOT SCALE DRAWINGS, USE	1
[DISCOVERY	1	DRAFT SALES PLAN - CT1	JOL	11/09/2024	SOPHIE ROSS			TARGA 13		H-WDCTRG10SA	FIGURED DIMENSIONS ONLY. CHECK AND VERIFY DIMENSIONS AND	.038
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0	© 2024					22 FRIENDSHIP DRIVE, S	SORELL TAS 7172		CLASSIC		F-WDCTRG10CLASA	DISCREPANCIES TO BE REPORTED TO THE DRAFTING OFFICE.	/ersio
						LOT / SECTION / CT:	COUNCIL:		SHEET TITLE:	SHEET No.:	SCALES:	744004	ate \
						167 / - / 184600	SORELL COUNCIL		GROUND FLOOR PLAN	4 / 13	1:100	714091	Тетр

ARE SUBJECT TO CHANGE. SH = SNAP HEADER SILL

BEDROOM WINDOW OPENINGS ABOVE 2m OFF THE SURFACE BENEATH TO BE RESTRICTED AS REQUIRED BY NCC 11.3.7 (VOLUME TWO)

ROOMS OTHER THAN BEDROOM WINDOW OPENINGS ABOVE 4m OFF THE SURFACE BENEATH TO BE RESTRICTED AS REQUIRED BY NCC 11.3.7 (VOLUME TWO)

REFER TO THE FOLLOWING DETAILS: BRICK COURSING W-BRIC-001

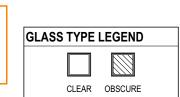


SECTION A-A

SCALE: 1:100

SUBJECT TO NCC 2022 (1 MAY 2023)

WATERPROOFING & PLUMBING



WINDOW TYPE LEGEND DOUBLE LOUVRE SLIDING

PLAN ACCEPTANCE BY OWNER SIGNATURE: SIGNATURE:

DATE:

DATE:

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714091

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orell Council

COLORBOND CORRUGATED / —CUSTOM ORB METAL ROOFING +

88 x 88mm NOM. PRIMED TIMBER POST

-ALUMINIUM STACKER DOOR

ENTRY DOOR

NORTH ELEVATION SCALE: 1:100

COLORBOND CORRUGATED / CUSTOM ORB METAL ROOFING +

SARKING

D03

EXISTING

GROUND LEVEL

SOUTH ELEVATION SCALE: 1:100

- EXISTING GROUND LEVEL

RL 26.267 - RIDGE LEVEL

RL 24.535 - TOP OF WALL

RL 22.090 - GROUND FLOOR

RL 21.720 - PAD LEVEL

RL 26.267 - RIDGE LEVEL

RL 24.535 - TOP OF WALL

RL 22.090 - GROUND FLOOR


RL 21.720 - PAD LEVEL

ARTICULATED FACE BRICKWORK

-1:2 CUT BATTER

ARTICULATED FACE BRICKWORK 1:2 FILL BATTER-

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	SPECIFICATION:	REVISION	[DRAWN	CLIENT:		HOUSE DESIGN:		HOUSE CODE:		
	DISCOVERY	DRAFT SALES PLAN - CT1	JOL	11/09/2024	SOPHIE ROSS		TARGA 13		H-WDCTRG10SA		
ı		PRELIM PLAN - INITIAL ISSUE	НМІ	30/09/2024	ADDRESS:		FACADE DESIGN:		FACADE CODE:		
	© 2024				22 FRIENDSHIP DRIVE, S	SORELL TAS 7172	CLASSIC		F-WDCTRG10CLASA		
					LOT / SECTION / CT:	COUNCIL:	SHEET TITLE:	SHEET No.:	SCALES:		
					167 / - / 184600	SORELL COUNCIL	ELEVATIONS / SECTION	5 / 13	1:100		

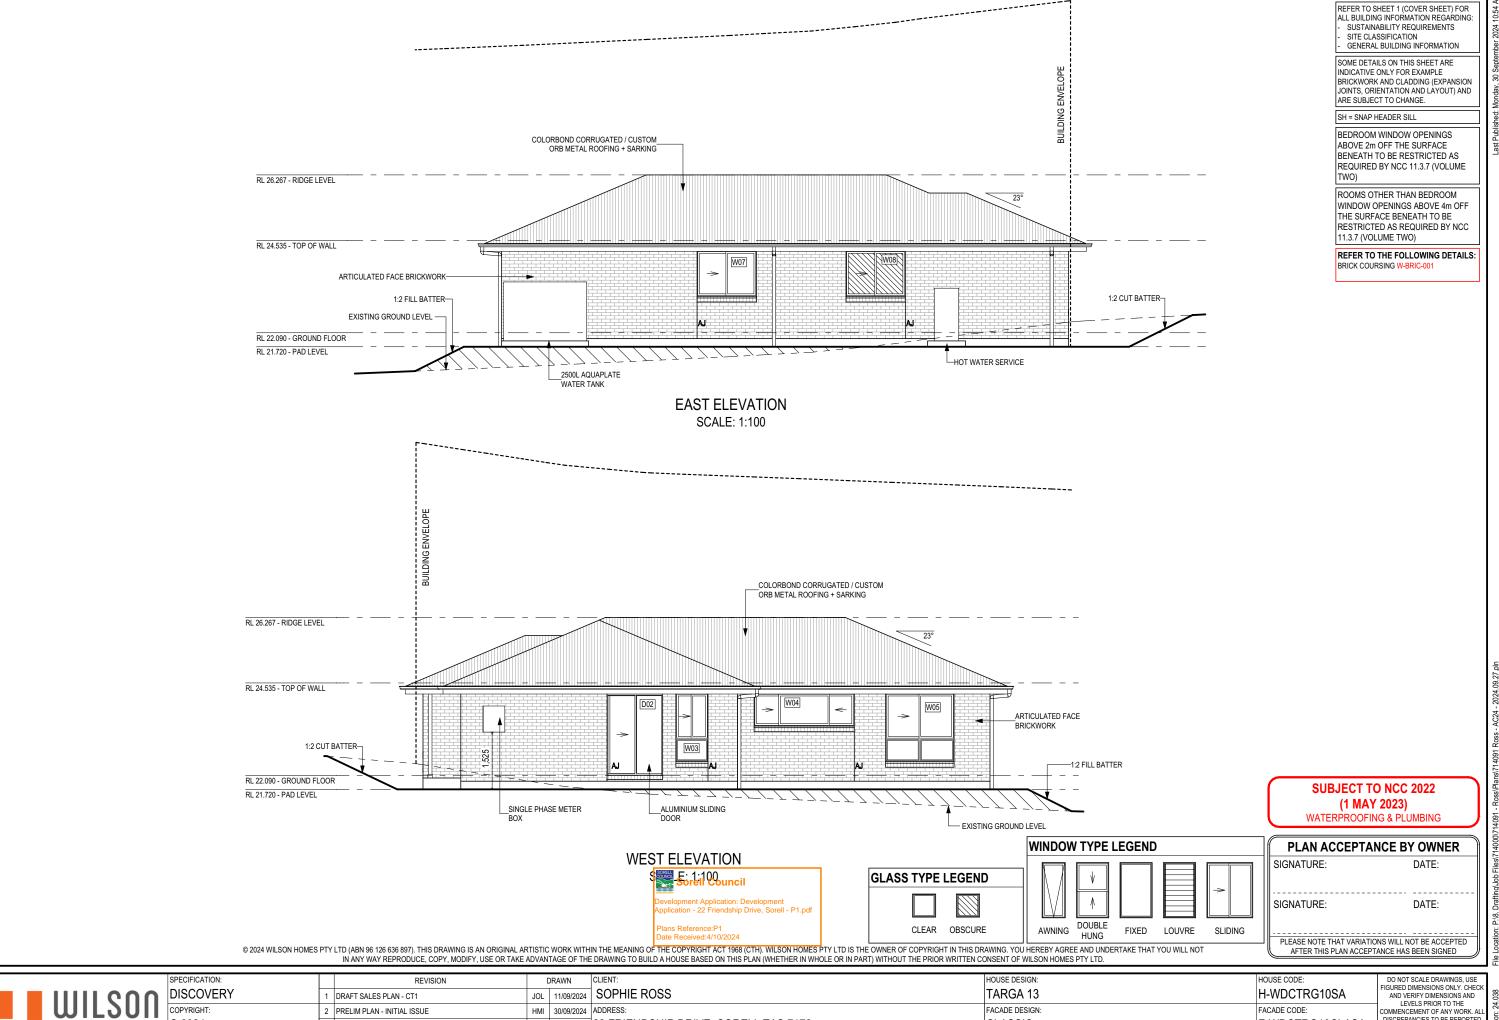

COMMENCEMENT OF ANY WORK. AL DISCREPANCIES TO BE REPORTED TO THE DRAFTING OFFICE. 22 FRIENDSHIP DRIVE, SORELL TAS 7172 CLASSIC F-WDCTRG10CLASA LOT / SECTION / CT: SHEET TITLE: COUNCIL: SHEET No.: SCALES: 714091 167 / - / 184600 SORELL COUNCIL **ELEVATIONS** 6 / 13 1:100

IN	NTERIOR WIND	ow 8	DOOR SCHEDULE					
	STOREY	QTY	CODE	TYPE	HEIGHT	WIDTH	GLAZING TYPE	ADDITIONAL INFORMATION
D	OOR		-					
	GROUND FLOOR	5	1000 SS	SQUARE SET OPENING	2,155	1,000	N/A	
	GROUND FLOOR	2	2 x 520	SWINGING	2,040	1,040	N/A	
	GROUND FLOOR	3	2 x 720	SWINGING	2,040	1,440	N/A	
	GROUND FLOOR	1	720	SWINGING	2,040	720	N/A	LIFT-OFF HINGES
	GROUND FLOOR	1	720	SWINGING	2,040	720	N/A	
	GROUND FLOOR	7	820	SWINGING	2,040	820	N/A	

PICTURE, TV RECESS AND SS WINDOW OPENINGS

QTY TYPE HEIGHT | WIDTH | AREA (m²)

as per N.C.C 11.3.6. **SUBJECT TO NCC 2022** (1 MAY 2023) Sorell Council WATERPROOFING & PLUMBING velopment Application: Development plication - 22 Friendship Drive, Sorell - P1.pdf

Windows supplied MUST HAVE Uw better and or equal to stated figures and SHGC within +/- 5% of stated figures. Restricted windows to have their openability restricted

Manufacturer - Clark Windows

Fixed Glass Panel Hinged Door

135 deg. Awning Bay Window

135 deg. Sliding Bay Window

90 deg. Awning Bay Window

90 deg. Sliding Bay Window

Window Type

Awning

Fixed

Sliding

Fixed Pane

Sliding Door

Stacking Door

Bifold Doors

Plans Reference:P1 Pate Received:4/10/2024

PLAN ACCEPTANCE BY OWNER SIGNATURE: DATE:

Glazing U-Value SHGC

6.5

4.1

5.9

3.2

6.4

4.2

5.9

3.2

6.0

4.3

6.1

3.6

6.3

3.8

6.5

4.1

6.5

4.2

6.5

4.1

6.5

4.2

6.1

4.4

0.67

0.57

0.75

0.67

0.76

0.59

0.75

0.67

0.62 0.55

0.74

0.66

0.74

0.66

0.67

0.57

0.76

0.59

0.67

Single

Double

Double

Single

Single

Single

Single

Double

Double

Single

Double

Single **Double**

Single

Double

Single

Single

Double

Double

Single

Double

Single

Double

Double

SIGNATURE: DATE:

PLEASE NOTE THAT VARIATIONS WILL NOT BE ACCEPTED AFTER THIS PLAN ACCEPTANCE HAS BEEN SIGNED

WILSON
HOMES

REFER TO SHEET 1 (COVER SHEET) FOR SUSTAINABILITY REQUIREMENTS

GENERAL BUILDING INFORMATION

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NOTE: INTERNAL DOORS TO WET AREAS WITH MECHANICAL VENTILATION TO BE UNDERCUT 20mm

	SPECIFICATION:	REVISION	DRAWN	CLIENT:		HOUSE DESIGN:		HOUSE CODE:	DO NOT SCALE DRAWINGS, USE FIGURED DIMENSIONS ONLY. CHECK
nn	DISCOVERY	1 DRAFT SALES PLAN - CT1	JOL 11/09/2024	SOPHIE ROSS		TARGA 13	TARGA 13		
UII	COPYRIGHT:	2 PRELIM PLAN - INITIAL ISSUE	HMI 30/09/2024	ADDRESS:		FACADE DESIGN:	FACADE DESIGN:		LEVELS PRIOR TO THE COMMENCEMENT OF ANY WORK. ALL
\overline{C}	© 2024			22 FRIENDSHIP DRIVE,	SORELL TAS 7172	CLASSIC		F-WDCTRG10CLASA	DISCREPANCIES TO BE REPORTED TO THE DRAFTING OFFICE.
\mathcal{O}				LOT / SECTION / CT:	COUNCIL:	SHEET TITLE:	SHEET No.:	SCALES:	744004
				167 / - / 184600	SORELL COUNCIL	WINDOW & DOOR SCHEDULES	7 / 13		714091

WHERE AG DRAIN IS < 1.5m FROM FOOTING, THE FOLLOWING ENGINEERING PRINCIPLES ARE

1. AG DRAIN TO BE CAPPED WITH 300mm OF CLAY TO PREVENT INGRESS OF SURFACE RUN-OFF UNLESS IT IS UNDER A PAVING SLAB ETC (AG DRAINS ARE DESIGNED FOR REMOVAL OF GROUND WATER, SURFACE WATER SHOULD BE DEALT WITH SEPARATELY).

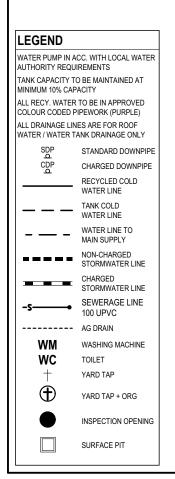
2. AG DRAIN TO HAVE A MINIMUM 1% TO A GRATED PIT WHICH DRAINS TO THE STORMWATER SYSTEM.

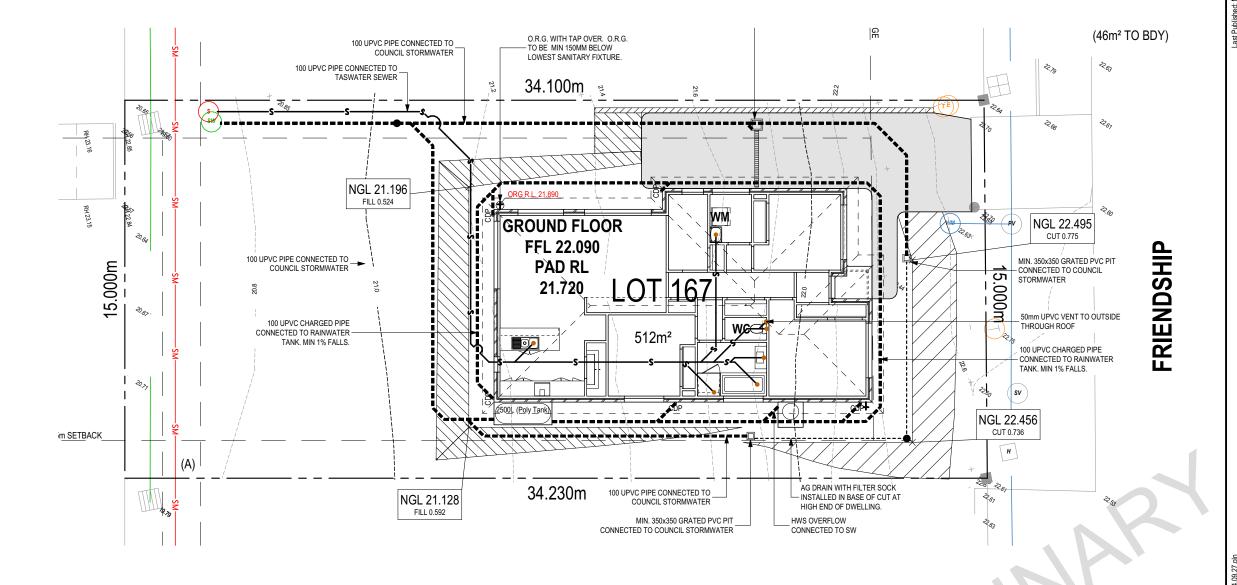
3. INSTALL A GEOTEXTILE FILTER SOCK TO THE SLOTTED DRAIN, AND ENCLOSE THE WHOLE DRAIN IN GEOFABRIC (TO THE UNDERSIDE OF CLAY CAPPING)

4. PROVIDE ADDITIONAL GRATED PITS/ OR INSPECTION OPENINGS ALONG THE LENGTH OF THE AG DRAIN AND AT THE HIGH POINT TO MAKE THE EFFECT OF A BLOCKAGE VISIBLE AND ENABLE A BLOCKAGE TO BE

5. <u>IF REQUIRED</u>. IN GROUND ABSORPTION TRENCHES TO BE TREATED WITH GYPSUM AT 1kg/m², AS PER THE DISPERSIVE SOILS REPORT

AG DRAIN DETAIL N.T.S.





Sorell Council ment Application: Development ion - 22 Friendship Drive, Sorell - P1.pdf ins Reference:P1 te Received:4/10/2024

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SUBJECT TO NCC 2022

(1 MAY 2023)

WATERPROOFING & PLUMBING

PLAN ACCEPTANCE BY OWNER

DATE:

DATE:

SIGNATURE:

SIGNATURE:

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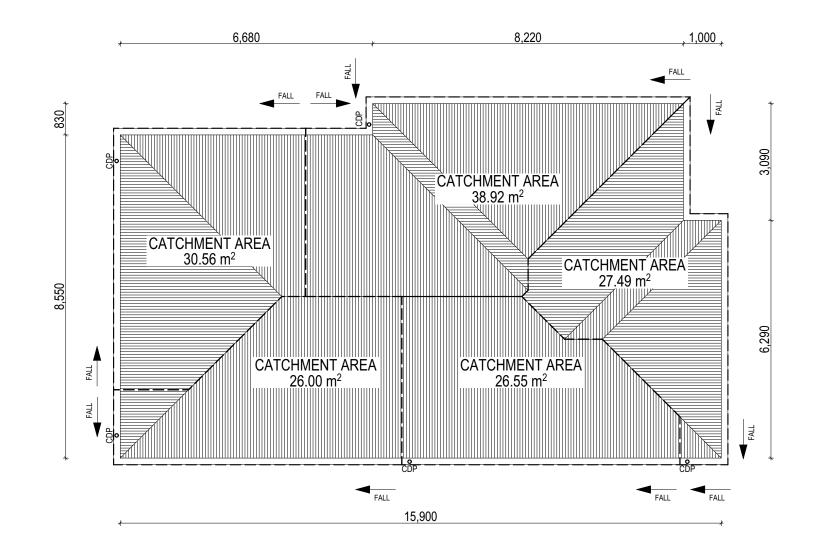
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© 2024					CLASSIC	F-WDCTRG10CLASA	DISCREPANCIES TO BE REPORTED	. Si
⊌ 2024				22 FRIENDSHIF DRIVE, SORELL TAS 1112	CLASSIC	F-WDCTNGTUCLASA	TO THE DRAFTING OFFICE.	\end{array}
				LOT / SECTION / CT: COUNCIL:	SHEET TITLE: SHEET No.:	SCALES:	744004	ate
		_		167 / - / 184600 SORELL COUNCIL	DRAINAGE PLAN 8 / 13	1:150	714091	흕
				IOI - IO4000 OOILLE GOONGIE		1.150	, , , , , , , ,	ē

WHERE DOWNPIPES ARE FURTHER THAN 1.2m AWAY FROM VALLEY REFER TO N.C.C. 7.3.5(2)

POSITION AND QUALITY OF DOWNPIPES ARE NOT TO BE ALTERED WITHOUT CONSULTATION WITH DESIGNER.

AREA'S SHOWN ARE SURFACE AREAS/ CATCHMENT AREAS, NOT PLAN AREAS

Roofi	ng Data	
	140.51	Flat Roof Area (excluding gutter and slope factor) (m²)
	152.64	Roof Surface Area (includes slope factor, excludes gutter) (m²)
Dowr	pipe roof	calculations (as per AS/NZA3500.3:2021)
Ah	149.52	Area of roof catchment (including 115mm Slotted Quad Gutter) (m²)
Ac	180.91	Ah x Catchment Area Multiplier for slope (Table 3.4.3.2 from AS/NZS 3500.3:2021) (1.21 for 23° pitch) (m²)
Ae	6300	Cross sectional area of 57 x 115 Slotted Quad Gutter (mm²)
DRI	113	Design Rainfall Intensity (determined from Table E1 from AS/NZS 3500.3:2021)
Acdp	64	Catchment area per Downpipe (determined from Figure 3.5(A) from AS/NZS 3500.3:2021) (m²)
Required Downpipes	2.82	Ac / Acdp
Downpipes Provided	5	



SOFFIT EAVE VENT PROPOSED LOCATION TO BE MIN. 1M FROM CORNER JOINT

SUBJECT TO NCC 2022 (1 MAY 2023) WATERPROOFING & PLUMBING

PLAN ACCEPTANCE BY OWNER								
SIGNATURE:	DATE:							
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					167 / - / 184600 SORELL COUNCIL R	ROOF DRAINAGE PLAN 9 / 13	1:100	714091	empl

COVERINGS LEGEND

NO COVERING

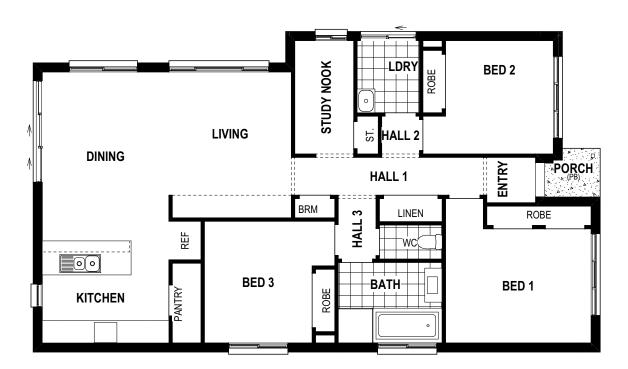
COVER GRADE CONCRETE

CARPET

LAMINATE

TILE (STANDARD WET AREAS)

TILE (UPGRADED AREAS)





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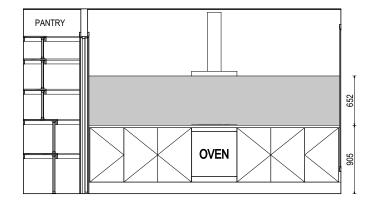
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SUBJECT TO NCC 2022

HOUSE CODE DO NOT SCALE DRAWINGS, USE FIGURED DIMENSIONS ONLY. CHECK DISCOVERY
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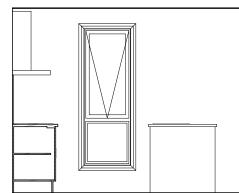


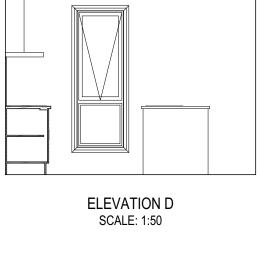


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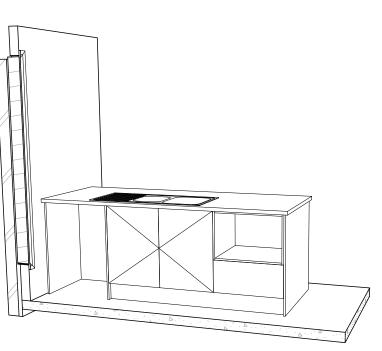
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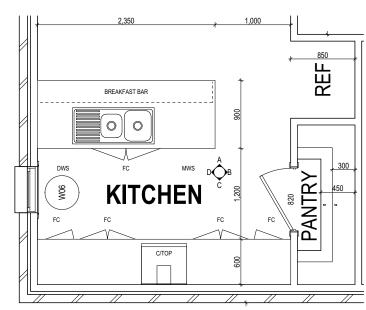




ELEVATION B

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KITCHEN PLAN SCALE: 1:50

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SIGNATURE: DATE:

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RSHR RAIL SHOWER ROSE SHOWER ROSE

ELBW SHOWER ELBOW CONNECTION MIX MIXER TAP HT HOT TAP CT COLD TAP HS HOB SPOUT WS WALL SPOUT

SC STOP COCK

ROBE HOOK

SR SHAMPOO RECESS SOAP SOAP HOLDER

SHLF SHELF

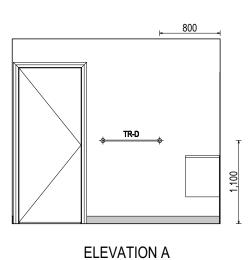
TOILET ROLL HOLDER TR-S TOWEL RAIL - SINGLE TR-D TOWEL RAIL - DOUBLE TL TOWEL LADDER TH TOWEL HOLDER TR TOWEL RACK TMB TUMBLER HOLDER RNG TOWEL RING

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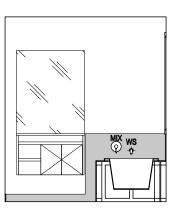
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STANDARD BATH HOB D-WETA-BATH003
WET AREA TILING LAYOUTS D-WETA-TILE002

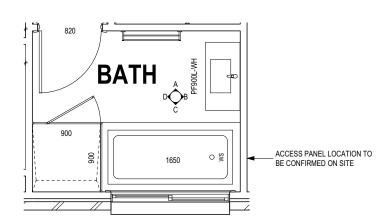
SQUARE SET WINDOWS G-WIND-SSET02 FULL HEIGHT TILING D-LINI-WETA



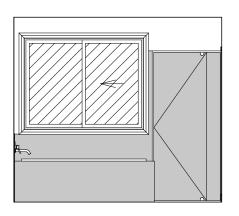
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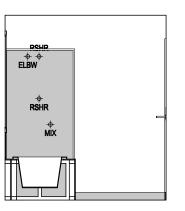
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BATHROOM PLAN SCALE: 1:50



ELEVATION C SCALE: 1:50



ELEVATION D SCALE: 1:50



				200		
SHAMPOO	RECESS SIZE	STRUCTURAL DIMENSIONS				
		WIDTH	HEIGHT	VC 0C		
"SMALL"	470 x 380mm	548mm	446mm	5		
"MEDIUM"	800 x 380mm	878mm	446mm	7		
"LARGE"	1500 x 380mm	1578mm	446mm	900		
REFER WILSON HOMES' DETAIL G-WETA-TILE01 FOR						

FURTHER DETAIL PRIOR TO INSTALLATION.

SUBJECT TO NCC 2022 (1 MAY 2023) WATERPROOFING & PLUMBING

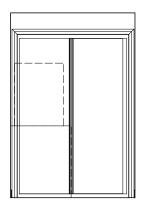
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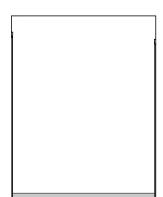
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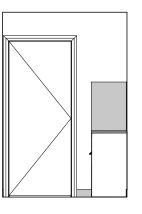
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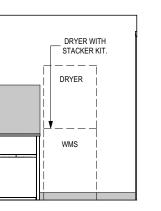





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(1 MAY 2023) WATERPROOFING & PLUMBING
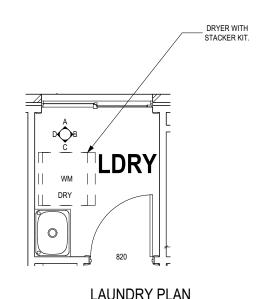
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