

NOTICE OF PROPOSED DEVELOPMENT

Notice is hereby given that an application has been made for planning approval for the following development:

SITE: 55 Friendship Drive, Sorell

PROPOSED DEVELOPMENT:

DWELLING

The relevant plans and documents can be inspected at the Council Offices at 47 Cole Street, Sorell during normal office hours, or the plans may be viewed on Council's website at www.sorell.tas.gov.au until **Monday 22**nd **July 2024.**

Any person may make representation in relation to the proposal by letter or electronic mail (<u>sorell.council@sorell.tas.gov.au</u>) addressed to the General Manager. Representations must be received no later than **Monday 22**nd **July 2024**.

APPLICANT: Wilson Homes

APPLICATION NO: DA 2024 / 158 - 1

DATE: 04 July 2024



Part B: Please note that Part B of this form is publicly exhibited.

Full description of Proposal:	Use:						
	Development:						
	Large or complex proposals s	Large or complex proposals should be described in a letter or planning report.					
Design and cons	struction cost of proposal:		\$				
Is all, or some th	ne work already constructed:		No: □	Yes: □			
Location of	Street address:						
proposed works:	Suburb:		Posto	code:			
	Certificate of Title(s) Volum	e:	•••••	Folio:			
Current Use of Site							
Current Owner/s: Name(s)							
Is the Property of Register?	on the Tasmanian Heritage	No: □	Yes: □	If yes, please provide written advice from Heritage Tasmania			
Is the proposal t than one stage?	o be carried out in more	No: □	Yes: □	If yes, please clearly describe in plans			
Have any potentially contaminating uses been undertaken on the site?			Yes: □	If yes, please complete the Additional Information for Non-Residential Use			
Is any vegetation proposed to be removed?			Yes: □	If yes, please ensure plans clearly show area to be impacted			
			Yes: □	If yes, please complete the Council or			
or Council? Crown land section on page 3 If a new or upgraded vehicular crossing is required from Council to the front boundary plea				· -			
	aded venicular crossing is req Phicular Crossing (and Associa						
•	rell.tas.gov.au/services/egine		no, appli	SORELL			
				Soroll Council			

Plans Reference: P1 Date Received: 17/06/2024

Development Application: Development Application - 55 Friendship Drive, Sorell.pdf

Declarations and acknowledgements

- I/we confirm that the application does not contradict any easement, covenant or restriction specified in the Certificate of Title, Schedule of Easements or Part 5 Agreement for the land.
- I/we consent to Council employees or consultants entering the site and have arranged permission and/or access for Council's representatives to enter the land at any time during normal business hours.
- I/we authorise the provision of a copy of any documents relating to this application to any person for the purposes of assessment or public consultation and have permission of the copyright owner for such copies.
- I/we declare that, in accordance with s52(1) of the Land Use Planning and Approvals Act 1993, that I have notified the owner(s) of the intention to make this application.
- I/we declare that the information in this application is true and correct.

Details of how the Council manages personal information and how you can request access or corrections to it is outlined in Council's Privacy Policy available on the Council website.

- I/we acknowledge that the documentation submitted in support of my application will become a public record held by Council and may be reproduced by Council in both electronic and hard copy format in order to facilitate the assessment process, for display purposes during public exhibition, and to fulfil its statutory obligations. I further acknowledge that following determination of my application, Council will store documentation relating to my application in electronic format only.
- Where the General Manager's consent is also required under s.14 of the *Urban Drainage Act 2013*, by making this application I/we also apply for that consent.

Applicant Signature:	Signature: Mark Page Date:
----------------------	----------------------------

Crown or General Manager Land Owner Consent

If the land that is the subject of this application is owned or administered by either the Crown or Sorell Council, the consent of the relevant Minister or the Council General Manager whichever is applicable, must be included here. This consent should be completed and signed by either the General Manager, the Minister, or a delegate (as specified in s52 (1D-1G) of the *Land Use Planning and Approvals Act 1993*).

Please note:

- If General Manager consent if required, please first complete the General Manager consent application form available on our website www.sorell.tas.gov.au
- If the application involves Crown land you will also need a letter of consent.
- Any consent is for the purposes of making this application only and is not consent to undertaken work or take any other action with respect to the proposed use or development.

1		being responsible for the
administration of land at		Sorell Council
declare that I have given permiss	Development Application: Development Application - 55 Friendship Drive, Sorell.pdf	
		Plans Reference: P1 Date Received: 17/06/2024
Signature of General Manager, Minister or Delegate:	Signature:	Date:



Proposed Residential Development – Lot 87, 55 Friendship Drive, Sorell

Bushfire Hazard Report

Applicant: Wilson Homes Job no. 713981



March 2024 J10070v1



Contents

1.0 Purpose	3
2.0 Summary	3
3.0 Introduction	3
4.0 Proposal	4
5.1 Methods4	
5.2 Site Description4	
6.0 Results	7
6.1 Property Access7	
6.2 Water supplies for fire fighting7	
6.3 Hazard Management Area8	
7.0 Compliance	8
8.0 Guidance	10
9.0 Further Information	10
10.0 References	11
11.0 Limitations Statement	12
Appendix A – Site Photos	
Appendix B - Site Plan	
Attachment 1 – Bushfire Hazard Management Plan	
Attachment 2 - Certificate of Others (form 55)	

Disclaimer

The measures contained in Australian Standard 3959-2018 cannot guarantee that a building will survive a bushfire event on every occasion. This is substantially due to the unpredictable nature and behaviour of fire and extreme weather conditions.

Reasonable steps have been taken to ensure that the information contained within this report is accurate and reflects the conditions on and around the lot at the time of assessment. The assessment has been based on the information provided by you or your designer.

Authorship

This report was prepared by Mark Van den Berg BSc. (Hons.) FPO (planning) of Geo Environmental Solutions. Base data for mapping: TasMap, Digital and aerial photography: Mark Van den Berg, GoogleEarth.

1.0 Purpose

This bushfire hazard report is intended to provide information in relation to the proposal. It will demonstrate compliance with the *Building Regulations 2016*, and the *Directors Determination – Bushfire Hazard Areas*, *version 1, 6th February 2020*. Provide a certificate of others (form 55) as specified by the Director of Building Control for bushfire hazard and give guidance by way of a certified bushfire hazard management plan which shows a means of protection from bushfires in a form approved by the Chief Fire Officer of the Tasmania Fire Service.

2.0 Summary

Site details & compliance

Title reference	185351/87
PID	9114889
Address	Lot 87, 55 Friendship Drive, Sorell
Applicant	Wilson Homes
Municipality	Sorell
Planning Scheme	Tasmanian Planning Scheme - Sorell
Zoning	General Residential
Land size	~0.089Ha
Bushfire Attack Level	BAL-12.5
Certificate of others (form 55)	Complete and attached
Bushfire Hazard Management Plan	Certified & Attached

Development of a new class 1a building at Lot 87, 55 Friendship Drive, Sorell requires demonstrated compliance with the *Building Regulations 2016*, and the *Directors Determination – Bushfire Hazard Areas*, *version 1.1, 8th February 2021*, the site is located in a bushfire prone area. The Bushfire attack level has been determined as 'BAL-12.5', provisions for property access, water supplies for firefighting, hazard management areas and construction standards will be required as detailed in this report and the Bushfire Hazard Management Plan (BHMP).

3.0 Introduction

This bushfire hazard report has been completed to form part of supporting documentation for a building permit application for the proposed development. The proposed development site has been identified as being in a bushfire prone area. A site-specific bushfire hazard management plan has been provided for compliance purposes.

4.0 Proposal

It is proposed that a new class 1a building and associated property access is developed at Lot 87, 55 Friendship Drive, Sorell (appendix B).

5.0 Bushfire Attack Level (BAL) Assessment

5.1 Methods

The Bushfire attack level has been determined through the application of section 2 of AS3959-2018 'Simplified Procedure'. Vegetation has been classified using a combination of onsite observations and remotely sensed data to be consistent with table 2.3 of AS359-2018. Slope and distances have been determined by infield measurement and/or the use of remotely sensed data (aerial/satellite photography, GIS layers from various sources) analysed with proprietary software systems. Where appropriate vegetation has been classified as low threat.

5.2 Site Description

The proposal is located at Lot 87, 55 Friendship Drive, Sorell, in the municipality of Sorell. Access to the lot will be by an existing crossover from Friendship Drive, a council-maintained road. The lot is ~0.089 Ha, is rectangular in shape and is located approximately 2.3km south-east of Weston Hill (Figure 1).

Adjacent lands surrounding the lot carry either grassland vegetation or low threat vegetation. Low threat vegetation occurs within a new subdivision in the early stages of development while grassland vegetation occurs on adjacent agricultural lands. At a landscape scale the site occurs on the eastern extent of the Sorell settled area which is characterised by residential development transitioning to agricultural lands which are dominated by grassland vegetation with remnant patches of native forest and woodland vegetation. The lot has gentle slopes with a generally westerly aspect which is unlikely to influence the bushfire attack at the site in this circumstance.

Vegetation surrounding the lot was assessed (Table 1) and described as 'grassland' or excluded from the assessment as low threat vegetation (as per AS3959-2018). The classified vegetation potentially having the greatest impact on the site occurs to the north of the site (Figure 2). The vegetation classification system as defined in AS 3959-2018 Table 2.3 and Figure 2.4 (A to H) has been used to determine vegetation types within 100 metres of the site (Table 1).



Figure 1. The lot in a topographical context (lot outlined in pink).



Figure 2. Shows the approximate location of the site (pink line) in the context of the adjacent lands and classified vegetation.

Table 1. Bushfire Attack Level (BAL) Assessment

Azimuth	Vegetation Classification	Effective Slope	Distance to Bushfire-prone vegetation	Hazard management area width	Bushfire Attack Level
	Grassland^	flat 0°	0 to 100 metres		
North				14 metres	BAL-12.5
	Exclusion 2.2.3.2 (e, f)^^	upslope	0 to 100 metres		
[
East				Title Boundary	BAL-LOW
	Exclusion 2.2.3.2 (e, f)^^	flat 0°	0 to 60 metres		
	Grassland^	flat 0°	60 to 100 metres	- :	541.1014
South -				Title boundary	BAL-LOW
	Exclusion 2.2.3.2 (e, f)^^	>0 to 5° downslope	0 to 100 metres		
,,, ,				-	
West				Title boundary BAL-LOV	BAL-LOW
	-				

Vegetation classification as per AS3959-2018 and Figures 2.4 (A) to 2.4 (H).
 Low threat vegetation as per Bushfire Prone Areas Advisory Note (BHAN) No.1-2014, version 3, 8/11/2017.
 Exclusions as per AS3959-2018, section 2.2.3.2, (a) to (f).

6.0 Results

The bushfire attack level for the site has been determined as BAL-12.5. The bushfire attack level for the building area has been assessed and classified as BAL-12.5, indicating a moderate to low risk profile. The site is susceptible to ember attack and may experience relatively low levels of radiant heat exposure. The construction components of the building are expected to withstand a maximum heat flux of 12.5 kW/m2.

6.1 Property Access

Property access is less than 30 metres in length, in this circumstance there are no specific design or construction standards for property access.

6.2 Water supplies for fire fighting

Dedicated water supplies for firefighting are provided by fire hydrants connected to a reticulated water supply system managed by Tas Water. The hydrants conform with the following specifications;

- The building area to be protected is located within 120 metres of a fire hydrant; and
- The distance has been measured as a hose lay, between the firefighting water connection point and the furthest part of the building area.

In this circumstance there are no further requirements for the provision of firefighting water supplies.

6.3 Hazard Management Area.

A hazard management area will need to be established and maintained for the life of the development and is shown on the BHMP. Guidance for the establishment and maintenance of the hazard management area is given below and on the BHMP.

A hazard management area is the area, between a habitable building or building area and the bushfire prone vegetation, which provides access to a fire front for firefighting, which is maintained in a minimal fuel condition and in which there are no other hazards present which will significantly contribute to the spread of a bushfire. This can be achieved through, but is not limited to the following strategies;

- Remove fallen limbs, sticks, leaf and bark litter;
- Maintaining grass at less than a 100mm height;
- Avoid or minimise the use of flammable mulches (especially against buildings);
- Thin out under-story vegetation to provide horizontal separation between fuels;
- Prune low-hanging tree branches (<2m from the ground) to provide vertical separation between fuel layers;
- Remove and or prune larger trees to maintain horizontal separation between canopies;
- Minimise the storage of flammable materials such as firewood;
- Maintaining vegetation clearance around vehicular access;
- Use low-flammability plant species for landscaping purposes where possible;

Clear out any accumulated leaf and other debris from roof gutters and other debris accumulation points.

7.0 Compliance

Table 2. Compliance with the Directors Determination - Bushfire Hazard Areas, version 1.1, 8th April 2021.

Requirements	Compliance
2.3.1 Construction Requirements	Clause 2.3.1 requires buildings to be constructed in accordance with AS3959-2018 or NASH standard – Steel Framed Construction in Bushfire Areas consistent with the BAL determined for the site.
	The BHMP specifies construction to BAL-12.5 standards of AS3959-2018.
	If the proposed buildings are designed and constructed in accordance with BAL-12.5 construction standards the development will comply with clause 2.3.1.
2.3.2 Property Access	Clause 2.3.2 requires property access to be designed and constructed to comply with table 2 of the determination and is applicable from the public roadway to within (at minimum) 90 metres of the furthest part of the building/s and includes access to a hardstand for the firefighting water point.
	Property access is less than 30 metres in length, in this circumstance there are no specific design or construction standards for property access.
	If the requirements of section 6.1 of this report are implemented the proposal will comply with clause 2.3.2.
2.3.3 Water Supply for Firefighting	Clause 2.3.3 requires that a new building constructed in a bushfire-prone area is provided with a dedicated firefighting water supply in accordance with tables 3A or 3B.
	Static water supplies consistent with table 3A are available to the site and are shown on the BHMP.
	If the requirements of section 6.2 of this report are implemented the proposal will comply with clause 2.3.3.
2.3.4 Hazard Management Areas	Clause 2.3.4 requires that new buildings in bushfire-prone areas are provided with an HMA which is compliant with table 4. The HMA must have the minimum separation distances required for the BAL determined for the site and, have an HMA established which reduces fuels and other hazards so that fuels and other hazards do not significantly contribute to the bushfire attack.
	HMA's are shown on the BHMP and are specified to the minimum widths required to achieve BAL-12.5 for the site. This report and the BHMP specify requirements for hazard management areas.
	If the HMA's are established in accordance with the BHMP the proposal will comply with clause 2.3.4
2.3.5 Emergency Plan	The proposal is for a class 1a building, in this circumstance there is no requirement for emergency plans for compliance purposes.

8.0 Guidance

The defendable space (hazard management area) around a building is critical for providing occupants and/or fire fighters with safe access to the building in order that firefighting activities may be undertaken. The larger the defendable space, the safer it will be for those defending the structure. Some desirable characteristics of a hazard management area are:

- The area directly adjacent to the building has a significant amount of flammable material removed such that there is little to no material available to burn around the building;
- Includes non-flammable areas such as paths, driveways, short cropped lawns;
- Establishment of orchards, vegetable gardens, dams or wastewater effluent disposal areas on the fire prone side of the building;
- Creating wind breaks and radiation shields such as non-combustible fences and low flammability hedges;
- It is not necessary to remove all vegetation from the defendable space, trees can provide protection from wind borne embers and radiant heat in some circumstances.

9.0 Further Information

For further information on preparing yourself and your property for bushfires visit the Tasmania Fire Service website at www.fire.tas.gov.au or phone 1800 000 699 for information on:

- Preparing a bushfire survival plan
- Preparing yourself and your home for a bushfire
- Guidelines for development in bushfire prone areas in Tasmania
- Fire resisting plants for the urban fringe and rural areas
- Using fire outdoors
- Fire permits
- Total fire bans
- Bushfires burning in Tasmania

10.0 References

Australian Building Codes Board, *National Construction Code, Building Code of Australia*, Australian Building Codes Board, Canberra.

Building Amendment (Bushfire-Prone Areas) Regulations 2016

Determination, Director of Building Control – Requirements for Building in Bushfire-Prone Areas (transitional), version 2.2 6th February 2020. Consumer, Building and Occupational Services, Department of Justice, Tasmania.

The Bushfire Planning Group 2005, *Guidelines for development in bushfire prone areas of Tasmania* – *Living with fire in Tasmania*, Tasmania Fire Service, Hobart.

Tasmania Fire Service 2013, *Building for Bushfire – Planning and Building in Bushfire-Prone Areas for Owners and Builders*.

Tasmanian Planning Scheme- Sorell, Tasmanian Planning Commission 2022, Tasmanian Planning Commission, Hobart.

Standards Australia, AS3959-2018 Construction of buildings in bushfire-prone areas. Sydney, NSW., Australia.

11.0 Limitations Statement

This Bushfire Hazard Report has been prepared in accordance with the scope of services between Geo-Environmental Solutions Pty. Ltd. (GES) and the applicant named in section 2. To the best of GES's knowledge, the information presented herein represents the Client's requirements at the time of printing of the Report. However, the passage of time, manifestation of latent conditions or impacts of future events may result in findings differing from that described in this Report. In preparing this Report, GES has relied upon data, surveys, analyses, designs, plans and other information provided by the Client and other individuals and organisations referenced herein. Except as otherwise stated in this Report, GES has not verified the accuracy or completeness of such data, surveys, analyses, designs, plans and other information.

The scope of this study does not allow for the review of every possible bushfire hazard condition and does not provide a guarantee that no loss of property or life will occur as a result of bushfire. As stated in AS3959-2018 "It should be borne in mind that the measures contained in this Standard cannot guarantee that a building will survive a bushfire event on every occasion. This is substantially due to the degree of vegetation management, the unpredictable nature and behaviour of fire, and extreme weather conditions". In addition, no responsibility is taken for any loss which is a result of actions contrary to AS3959-2018 or the Tasmanian Planning Commission Bushfire code.

This report does not purport to provide legal advice. Readers of the report should engage professional legal practitioners for this purpose as required. No responsibility is accepted for use of any part of this report in any other context or for any other purpose by third party.

Appendix A – Site Photos



Figure 3. Northern azimuth from the site.



Figure 4. Eastern azimuth from the site.

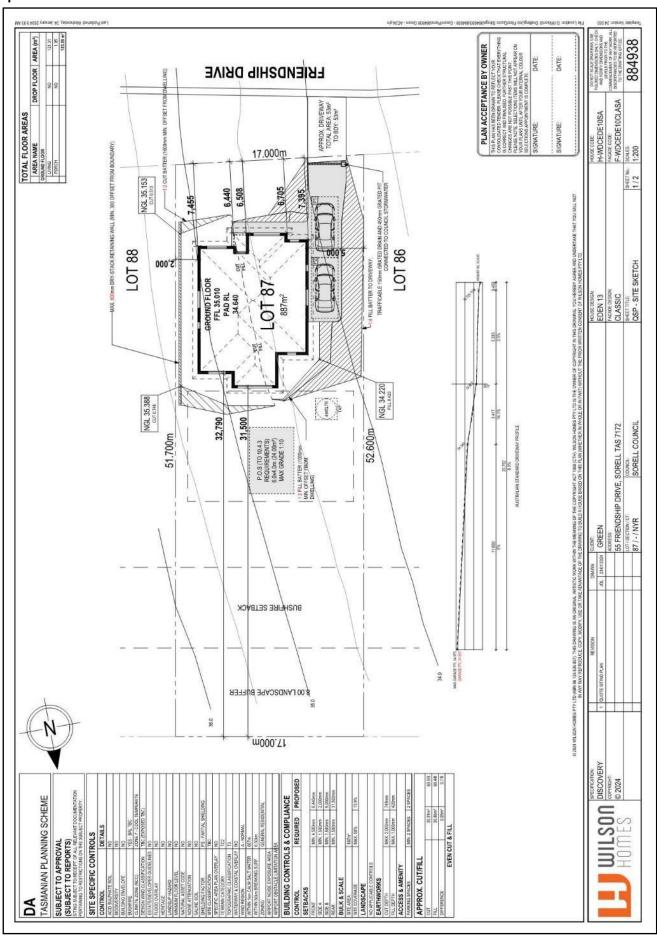


Figure 5. Southern azimuth from the site.




Figure 6. Western azimuth from the site.

Appendix B - Site Plan



BUSHFIRE HAZARD MANAGEMENT PLAN

Bushfire Hazard Management Plan, Lot 87, 55 Friendship Drive, Sorell. March 2024. J10070v1. Tasmanian Planning Scheme - Sorell

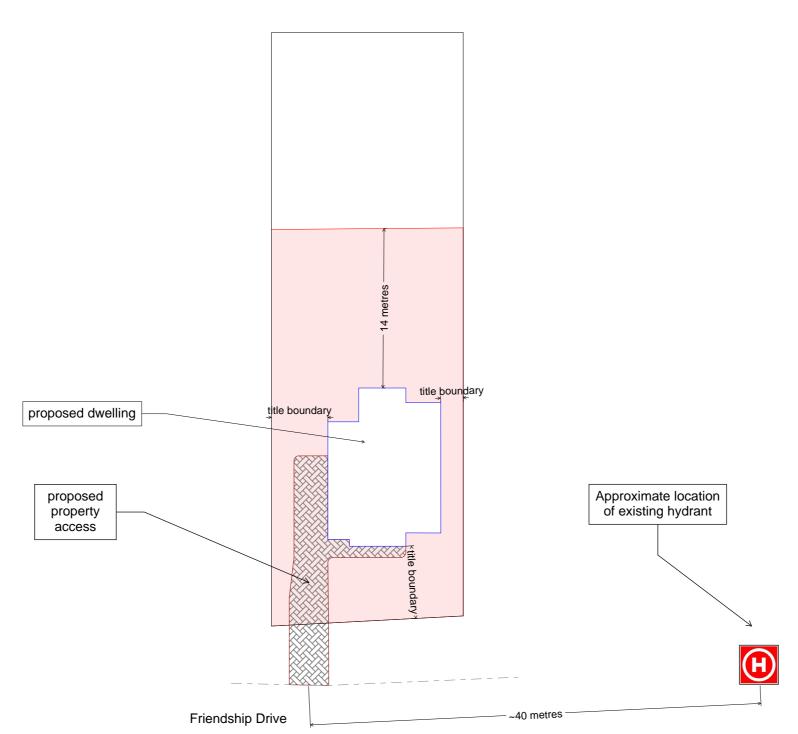







GEO-ENVIRONMENTAL

SOLUTIONS

29 Kirksway Place, Battery Point.
T| 62231839 E| office@geosolutions.net.au

Building Specifications to BAL-12.5 of AS3959-2018

Hazard Management Area

A hazard management area is the area, between a habitable building or building area and the bushfire prone vegetation, which provides access to a fire front for firefighting, which is maintained in a minimal fuel condition and in which there are no other hazards present which will significantly contribute to the spread of a bushfire. This can be achieved through, but is not limited to the following actions;

- Remove fallen limbs, sticks, leaf and bark litter;
- Maintain grass at less than a 100mm height;
- Remove pine bark and other flammable mulch (especially from against buildings);
- Thin out under-story vegetation to provide horizontal separation between fuels;
- Prune low-hanging tree branches (<2m from the ground) to provide (vertical separation between fuel layers;
- Prune larger trees to maintain horizontal separation between canopies;
- Minimise the storage of flammable materials such as firewood;
- Maintain vegetation clearance around vehicular access and water supply points;
- Use low-flammability species for landscaping purposes where appropriate;
- Clear out any accumulated leaf and other debris from roof gutters and other accumulation points.

It is not necessary to remove all vegetation from the hazard management area, trees may provide protection from wind borne embers and radiant heat under some circumstances.

Certification No. J10070

/Winderson

Mark Van den Berg Acc. No. BFP-108 Scope 1, 2, 3A, 3B, 3C.

Hazard Management Areas

firefighting water supplies.

hydrant: and

Compliance Requirements

requirements for property access.

Standards for Property Access

Water Supplies for Firefighting

hydrants conform with the following specifications;

connection point and the furthest part of the building area.

A hazard management area is required to be established and maintained for the life of the building and is shown on this BHMP. Guidance for the establishment and maintenance of the hazard management area is also provided.

Property access is not required for a fire appliance to access a firefighting

Dedicated water supplies for firefighting are provided by fire hydrants

•The building area to be protected is located within 120 metres of a fire

In this circumstance there are no further requirements for the provision of

water point. In this circumstance there are no specific design or construction

connected to a reticulated water supply system managed by Tas Water. The

•The distance has been measured as a hose lay, between the firefighting water

Building Area

Approx. existing hydrant location

Hazard Management Area

Do not scale from these drawings. Dimensions to take precedence over scale. Written specifications to take precedence over diagrammatic representations.

Wilson Homes 250 Murray Street Hobart, Tasmania 7000 C.T.: 185351/87 PID: 9114889

Date: 07/03/2024

Bushfire Hazard Management Plan Lot 87, 55 Friendship Drive, Sorell. March 2024. J10070v1. Bushfire Management Report Lot 87, 55 Friendship Drive, Sorell. March 2024. J10070v1. Drawing Number: A01 Sheet 1 of 1 Prepared by: MvdB

CERTIFICATE OF QUALIFIED PERSON – ASSESSABLE ITEM

Section 321

To:	Wilson Homes				Owner /Agent			
	250 Murray Street				Address	Form	, 5	5
	Hobart		70	00	Suburb/postcode			
Qualified perso	on details:							
Qualified person:	Mark Van den Berg							
Address:	29 Kirksway Place				Phone No:	03	6223	3 1839
	Battery Point TAS		70	04	Fax No:			
Licence No:	FP-108 Email address: n	างล	nde	nberg	@geosolutio	ns.net	i.au	
Qualifications and Insurance details:	Accredited to report on bushf hazards under Part IVA of the Service Act. BFP-108 scope 1, 2, 3a, 3b, Sterling Insurance PI policy N 17080170	e Fi 3c.	ire	Directo	iption from Column or's Determination - alified Persons for <i>i</i>	- Certifica		
Speciality area of expertise:	Analysis of bushfire hazards bushfire prone areas	in		Direct	ription from Columr or's Determination alified Persons for	- Certifica		
Details of work								
Address:	Lot 87, 55 Friendship Drive]	Lot No:		
	Sorell		71	72	Certificate of	title No:	185 7	351/8
The assessable item related to this certificate:	New building work in a bushf area.	ire	pror	ne	(description of the certified) Assessable item - a material; - a design - a form of coldon of coldon of coldon of coldon of performed	includes - nstruction componer umbing s	able iten - nt, buildi ystem	ing
Certificate deta	nils:							

Certificate type:	Bushfire Hazard	(description from Column 1 of Schedule 1 of the Director's Determination - Certificates by Qualified Persons for Assessable Items n)	
This certificate is	in relation to the above assessable item, at an	y stage, as part of - (tick one)	
	building work, plumbing work or pl	lumbing installation or demolition work:	X
	or	_	
	a building, tempo	orary structure or plumbing installation:	
In issuing this certif	icate the following matters are relevant –		
Documents:	The attached Bushfire Hazard Report Plan for the address detailed above		nt
Relevant calculations:	Reference the above report.		
References:			
	AS3959-2018 Construction of Buildi Directors Determination for: Bu Requirements for Building in Bushfir	ushfire Hazard Areas v1.1 o	or

Substance of Certificate: (what it is that is being certified)

Bushfire Attack Level Assessment in accordance with AS3959-2018 and determination of other mitigation measures as required by the relevant Directors Determination as cited in the Bushfire Hazard Report.

Scope and/or Limitations

Scope: This report was commissioned to identify the Bushfire Attack Level for the existing property. Limitations: The inspection has been undertaken and report provided on the understanding that;-1. The report only deals with the potential bushfire risk all other statutory assessments are outside the scope of this report. 2. The report only identifies the size, volume and status of vegetation at the time the site inspection was undertaken. 3. Impacts of future development and vegetation growth have not been considered.

I certify the matters described in this certificate.

Qualified person:

Signed:

Certificate No: J10070

Date:

07/03/2024

PORCH

1.01 123.29 m² ALL CONSTRUCTION TO BE IN ACCORDANCE WITH NCC 2022 AND APPLICABLE AUSTRALIAN STANDARDS AT TIME OF APPROVAL

AS & NCC COMPLIANCE

SLAB IN ACCORDANCE WITH AS 2870. REFER TO ENGINEERS DETAILS FOR ALL SLAB DETAILS. BRICK CONTROL JOINTS PROVIDED IN ACCORDANCE WITH NCC 2022.

ALL STEEL FRAMING TO BE DESIGNED TO AS 4100-2020 OR AS/NZS

INSULATION TO BE INSTALLED IN ACCORDANCE WITH NCC 2022 AND ALL APPLICABLE AUSTRALIAN STANDARDS.

TERMITE PROTECTION IN ACCORDANCE WITH AS 3660 AND NCC 2022. GLAZING IN ACCORDANCE WITH AS 1288 AND NCC 2022. SMOKE ALARMS IN ACCORDANCE WITH AS 3786 AND NCC 2022. INTERNAL WATERPROOFING IN ACCORDANCE WITH NCC 2022

HOUSING PROVISIONS PART 10.2. EXTERNAL WATERPROOFING IN ACCORDANCE WITH AS 3740 AND AS

WET AREA FLOORS TO FALL TO FLOOR WASTES AT MIN. 1:80 AND MAX.

1:50 GRADE (IF APPLICABLE). CONDENSATION MANAGEMENT IN ACCORDANCE WITH NCC 2019 BUILDING SEALING IN ACCORDANCE WITH NCC 2022. SERVICES IN ACCORDANCE WITH NCC 2022.

EARTHWORKS IN ACCORDANCE WITH AS 3798-2007. EXTERNAL WALL WRAP (SARKING) IN ACCORDANCE WITH NCC 2022 (IF

OUTE OBEOUTIO CONTROL O

EXHAUST FANS DUCTED TO OUTSIDE AIR (IF APPLICABLE).

	SITE SPECIFIC CONT	ROLS		
	CONTROL	DETAILS		
	ACID SULPHATE SOIL	NO		
	BIODIVERSITY	NO		
	BUILDING ENVELOPE	NO		
1	BUSHFIRE	BAL-12.5		
	CLIMATE ZONE (NCC)	ZONE 7 - COOL TEMPERATE		
	DESIGN WIND CLASSIFICATION	N3 (EXPOSED TBC)		
1	ESTATE/DEVELOPER GUIDELINES	NO		
]	FLOOD OVERLAY	NO		
1	HERITAGE	NO		
	LANDSLIP HAZARD	NO		
	MINIMUM FLOOR LEVEL	NO		
	NATURAL ASSET CODE	NO		
	NOISE ATTENUATION	NO		
	SALINE SOIL	NO		
	SHIELDING FACTOR	NS - NO SHIELDING		
	SITE CLASSIFICATION	M		
	SPECIFIC AREA PLAN OVERLAY	NO		
	TERRAIN CATEGORY	TC2.5		
	TOPOGRAPHIC CLASSIFICATION	T2		
	WATERWAY & COASTAL OVERLAY	NO		
	WIND REGION	A - NORMAL		
	WITHIN 1km CALM SALT WATER	607m		
	WITHIN 50km BREAKING SURF	6.50km		
	ZONING	GENERAL RESIDENTIAL		
	AIRPORT NOISE EXPOSURE AREA			
	AIRPORT OBSTACLE LIMITATION AF	REA		

BUILDING CONTROLS & COMPLIANCE					
CONTROL	REQUIRED	PROPOSED			
SETBACKS					
FRONT	MIN. 4,500mm	6,708mm			
SIDE A	MIN. 1,500mm	1,999mm			
SIDE B	MIN. 1,500mm	5,001mm			
REAR	MIN. 1,500mm	31,018mm			
BULK & SCALE					
SITE AREA	886m²				
SITE COVERAGE	MAX. 50% 13.91%				
LANDSCAPE					
NO APPLICABLE CONTROLS					
EARTHWORKS					
CUT DEPTH	MAX. 2,000mm	680mm			
FILL DEPTH	MAX. 1,000mm	422mm			
ACCESS & AMENITY					
PARKING SPACES	MIN. 2 SPACES	2 SPACES			

ALL


SHEET

2024.06.06

RT2


DATE DRAWN CHECK

RCS

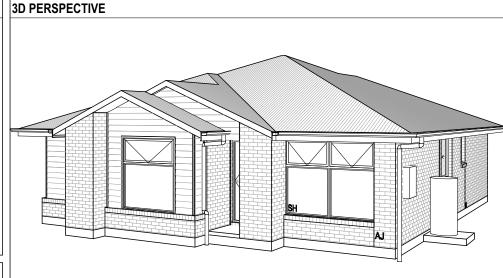

NOTE TO OWNER

THESE PLANS MAY FEATURE WORKS THAT ARE EXCLUDED FROM THE SCOPE OF WORKS WITH THE BUILDER. BUT THEY HAVE BEEN INCLUDED IN THESE DRAWINGS TO ASSIST IN THE OVERALL PLANNING AND ASSESSMENT OF THE BUILDING PROJECT. EXAMPLES OF SOME REGULARLY EXCLUDED WORKS INCLUDE DRIVEWAYS, RETAINING WALLS, SOLAR PANEL SPACING AND SITE DRAINAGE. PLEASE REFER TO YOUR SCOPE OF WORKS AND COLOUR SELECTIONS DOCUMENTATION FOR DETAILS OF INCLUDED WORKS. SOME DETAILS ARE INDICATIVE ONLY FOR EXAMPLE FLOORING, TILING, BRICKWORK AND CLADDING (EXPANSION JOINTS, ORIENTATION AND LAYOUT) AND ARE SUBJECT TO CHANGE.

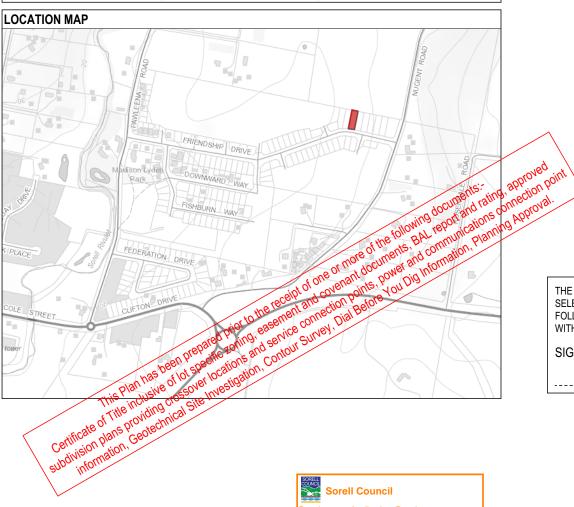

BUSHFIRE REQUIREMENTS - BAL-12.5

THE BUILDER USES MATERIALS THAT COMPLY WITH AS 3959-2018 OR HAVE BEEN TESTED TO AS 1530.8.1 IN ACCORDANCE WITH AS 3959-2018

PROVIDE FOIL FACED BLANKET INSULATION TO ALL COLORBOND SHEET ROOFING.

PROVIDE SARKING TO ALL TILED ROOFING INCLUDING PRESSTITE TO

VALLEYS. PROVIDE BAL-12.5 RATED DEKTITE TO ALL AIR VENTS ON ROOF. PROVIDE BAL-12.5 RATED ALUMINIUM MESH TO ALL SOFFIT AND EAVE

PROVIDE BAL-12.5 RATED ALUMINIUM MESH TO ALL EXHAUST VENTS.

VALLS, POSTS AND BEAMS:

PROVIDE SPARK ARRESTORS TO ALL EXTERNAL BRICKWORK. EXTERNAL TIMBER POSTS WITHIN 400mm OF ADJACENT FINISHED FLOOR LEVEL TO BE BUSHFIRE-RESISTING TIMBER UNLESS MOUNTED ON STIRRUPS TO PROVIDE MIN. 75mm CLEARANCE ABOVE ADJACENT FINISHED FLOOR LEVEL.

VINDOWS AND DOORS: PROVIDE FLYSCREENS WITH CORROSION RESISTANT MESH TO ALL OPERABLE WINDOW SASHES (NO REQUIREMENT TO SCREEN BI-FOLD FRENCH / SLIDING / STACKER DOORS).

PROVIDE BAL-12.5 RATED ALUMINIUM WINDOWS AND EXTERNAL GLASS SLIDING / STACKER DOORS.

SPECIFIED ALUMINIUM FRENCH DOORS HAVE BEEN TESTED TO AS 1530.8.1 WITHOUT SCREENS. SPECIFIED ALUMINIUM WINDOWS HAVE BEEN TESTED TO AS 1530.8.1

WITHOUT SCREENS TO FIXED PANELS.

PROVIDE ALUMINIUM DOOR JAMBS TO ALL EXTERNAL TIMBER DOORS.
PROVIDE SAFETY SCREENS WITH CORROSION RESISTANT MESH TO EXTERNAL TIMBER HUNG DOORS (IF REQUIRED)

PROVIDE SEAL TO ALL GARAGE PANELIFT / ROLLER DOORS

PROVIDE COPPER WATER PIPES FROM WATER TANK TO HOUSE.

THE OWNERS ACKNOWLEDGE THAT THESE CONTRACT PLANS MAY NOT REFLECT ALL THE SELECTIONS THAT HAVE BEEN MADE OR CHANGES REQUESTED. THE OWNERS AGREE THAT FOLLOWING THE COLOUR SELECTIONS VARIATION OR UPDATING OF PLANS, THEY WILL BE PROVIDED WITH CONSTRUCTION PLANS FOR SIGNATURE PRIOR TO COMMENCEMENT OF CONSTRUCTION.

SIGNATURE:

BUILDING INFORMATION

EXT. WALLS R2.0 BATTS (EXCL. GARAGE)

BIAX SLAB

WALL WRAP TO ENTIRE HOUSE

ROOF PITCH (U.N.O.)

ELECTRICITY SUPPLY

GAS SUPPLY

ROOF MATERIAL

ROOF COLOUR

WALL MATERIAL

SLAB CLASSIFICATION

INSULATION

ROOF CEILING

FLOOR

GROUND FLOOR TOP OF WALL HEIGHT(S) 2445mm

NOTE: CEILING HEIGHT 45mm LOWER THAN TOP OF WALL

SINGLE PHASE

SHEET METAL

BRICK VENEER

CLADDING

NONE

TBC

MIN. 60mm FOIL FACED BLANKET UNDER ROOFING

R4.1 BATTS (EXCL. GARAGE, ALFRESCO & PATIO)

INT. WALLS R2.0 BATTS ADJACENT TO GARAGE AND AS PER PLAN

DATE:

SUBJECT TO NCC 2022 (1 MAY 2023)

WATERPROOFING & PLUMBING

PLAN ACCEPTANCE BY OWNER SIGNATURE: DATE: SIGNATURE: DATE:

PLEASE NOTE THAT VARIATIONS WILL NOT BE ACCEPTED AFTER THIS PLAN ACCEPTANCE HAS BEEN SIGNED.

		SI
	WILSON	С
	MILOUII	С
	IIOMEC	0
	ПППЕЭ	

PRELIMINARY PLAN SET

PRELIMINARY PLAN SET - INITIAL ISSUE

AMENDMENT


No.

		IN ANY WAY REPRODUCE, COPY, MODIFY, USE OR TAKE	ADVAN'	TAGE OF TH	E DRAWING TO BUILD A HOUSE BASED ON THIS PLAN (WHETHER IN WHOLE OR IN PART) WITHOUT THE PRIOR WRITTEN CO	ONSENT OF WILSON HOMES PTY LTD.
ECIFICATION:		REVISION		RAWN	CLIENT:	HOUSE DESIGN:
SCOVERY	1	QUOTE SITING PLAN	JOL	23/01/2024	JYE GREEN	EDEN 13

© 2024 WILSON HOMES PTY LTD (ABN 96 126 636 897). THIS DRAWING IS AN ORIGINAL ARTISTIC WORK WITHIN THE MEANING OF THE COPYRIGHT ACT 1968 (CTH). WILSON HOMES PTY LTD IS THE OWNER OF COPYRIGHT IN THIS DRAWING. YOU HEREBY AGREE AND UNDERTAKE THAT YOU WILL NOT

SPECI HOUSE CODE DO NOT SCALE DRAWINGS, USE FIGURED DIMENSIONS ONLY, CHEC DISC H-WDCEDE10SA AND VERIFY DIMENSIONS AND I EVELS PRIOR TO THE COPYRIGHT: RT2 09/05/2024 ADDRESS: FACADE CODE: FACADE DESIGN: 2 DRAFT SALES PLAN- CT-1 CONTOUR UPDATE RT2 06/06/2024 55 FRIENDSHIP DRIVE, SORELL TAS 7172 © 2024 **NEWPORT** F-WDCEDE10NWPTA 3 PRELIM PLANS- INITIAL ISSUE TO THE DRAFTING OFFICE. SHEET TITLE: LOT / SECTION / CT: SHEET No . SCALES COUNCIL 713981 87 / - / 185351 SORELL COUNCIL COVER SHEET 1 / 13 1:100

cation - 55 Friendship Drive, Sorell.pdf

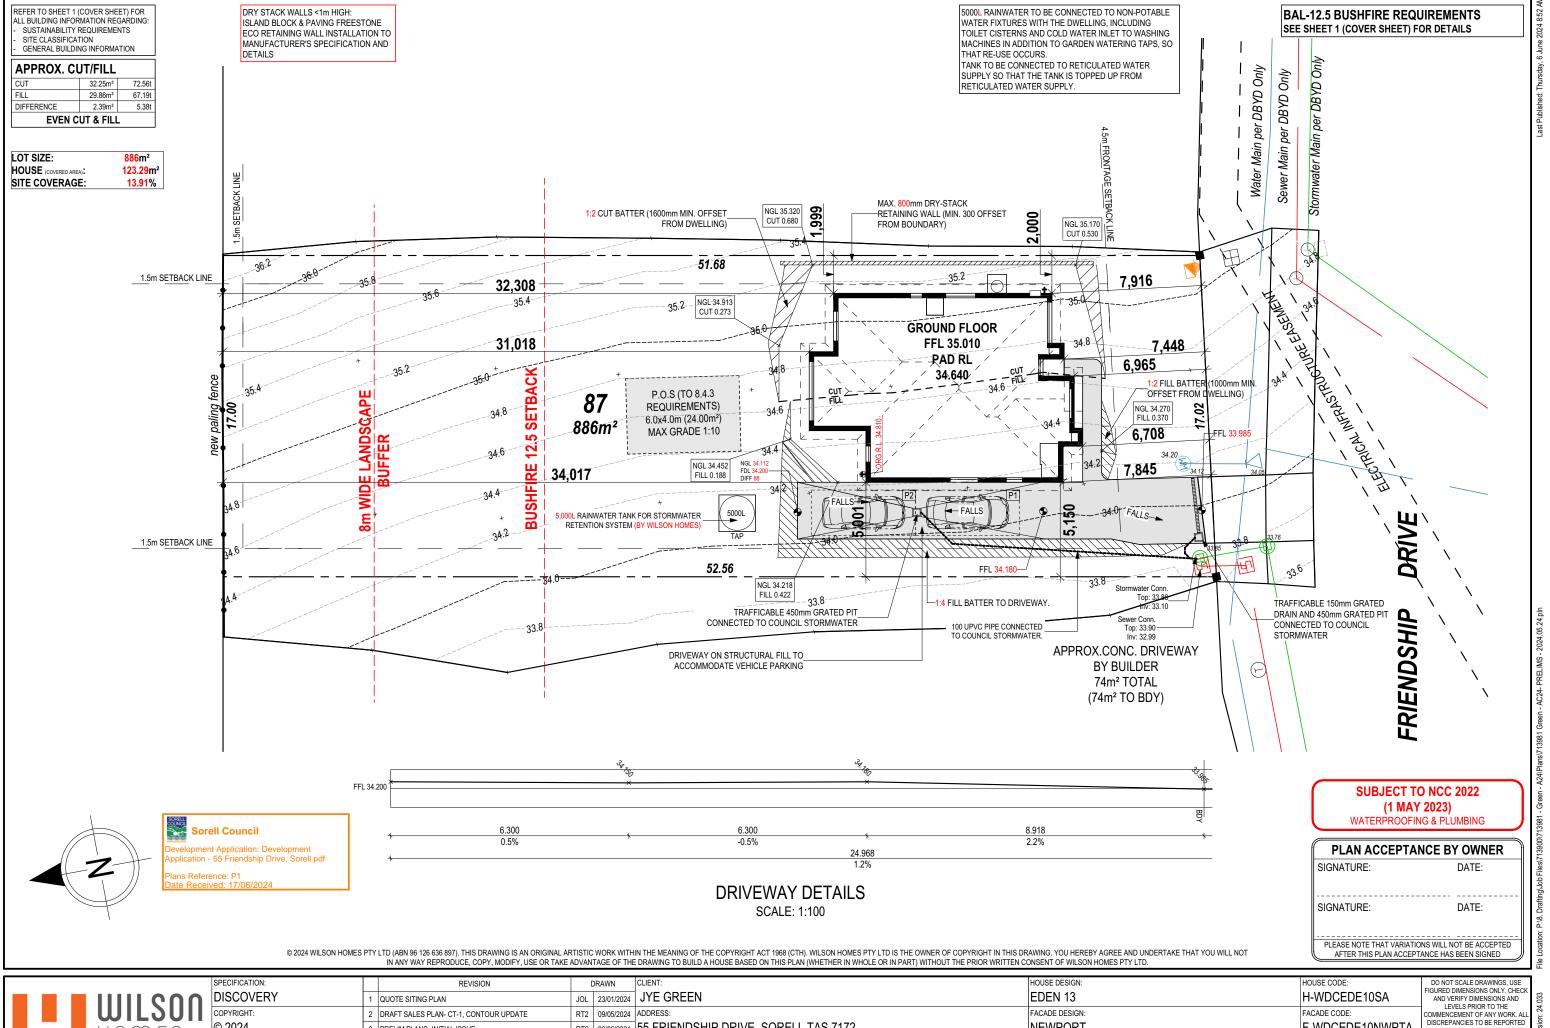

WILSON
HOMES

	SPECIFICATION:		REVISION			CLIENT:		HOUSE DESIGN:		HOUSE CODE:	DO NOT SCALE DRAWINGS, USE FIGURED DIMENSIONS ONLY. CHECK	
\cap	DISCOVERY	1	QUOTE SITING PLAN	JOL	23/01/2024	JYE GREEN		EDEN 13		H-WDCEDE10SA	AND VERIFY DIMENSIONS AND	.U.
Ш	COPYRIGHT:	2				ADDRESS:		FACADE DESIGN:		FACADE CODE:	LEVELS PRIOR TO THE COMMENCEMENT OF ANY WORK. ALL	
	© 2024	3	PRELIM PLANS- INITIAL ISSUE	RT2	06/06/2024	55 FRIENDSHIP DRIVE,	SORELL TAS 7172	NEWPORT		F-WDCEDE10NWPTA	TO THE DRAFTING OFFICE.	/ersir
							COUNCIL:	SHEET TITLE:		SCALES:	712001	ate
						87 / - / 185351	SORELL COUNCIL	SITE PLAN	2 / 13	1:200, 1:100	713981	eli e


ALL VEGETATION OUTSIDE THE BUILDING ZONE WILL BE MAINTAINED.

OWNER TO STABILISE THE SITE ON COMPLETION OF THE BUILD WITH TURF LAWNS, GRASS SEEDS, NATIVE GROUND COVERS AND/ OR MULCH SPREAD TO A DEPTH OF 75-100mm

THE FOLLOWING IS A STANDARD APPROACH. SEDIMENT AND EROSION CONTROL MEASURES WILL BE REVIEWED PRIOR TO COMMENCING WORK AND INSTALLED BASED ON THE OUTCOME OF THAT REVIEW.

1. ALL EROSION AND SEDIMENT CONTROL STRUCTURES TO BE INSPECTED EACH WORKING DAY AND MAINTAINED IN GOOD WORKING ORDER.

- 2. ALL GROUND COVER VEGETATION OUTSIDE THE IMMEDIATE BUILDING AREA TO BE PRESERVED DURING THE BUILDING
- 3. ALL EROSION AND SEDIMENT CONROL MEASURES TO BE INSTALLED PRIOR TO COMMENCEMENT OF MAJOR EARTHWORKS.
- 4. STOCKPILES OF CLAYEY MATERIAL TO BE COVERED WITH AN IMPERVIOUS SHEET. 5. ROOF WATER DOWNPIPES TO BE CONNECTED TO THE PERMAMENT UNDERGROUND STORMWATER DRAINAGE SYSTEM AS SOON AS PRACTICAL AFTER THE ROOF IS LAID.
- 6. DIVERSION DRAINS ARE TO BE CONNECTED TO A LEAGAL DISCHARGE POINT (COUNCIL STORMWATER SYSTEM, WATERCOURSE OR ROAD DRAIN). 7. SEDIMENT RETENTION TRAPS INSTALLED AROUND THE INLETS TO THE STORMWATER SYSTEM TO PREVENT SEDIMENT & OTHER DEBRIS BLOCKING THE DRAINS.

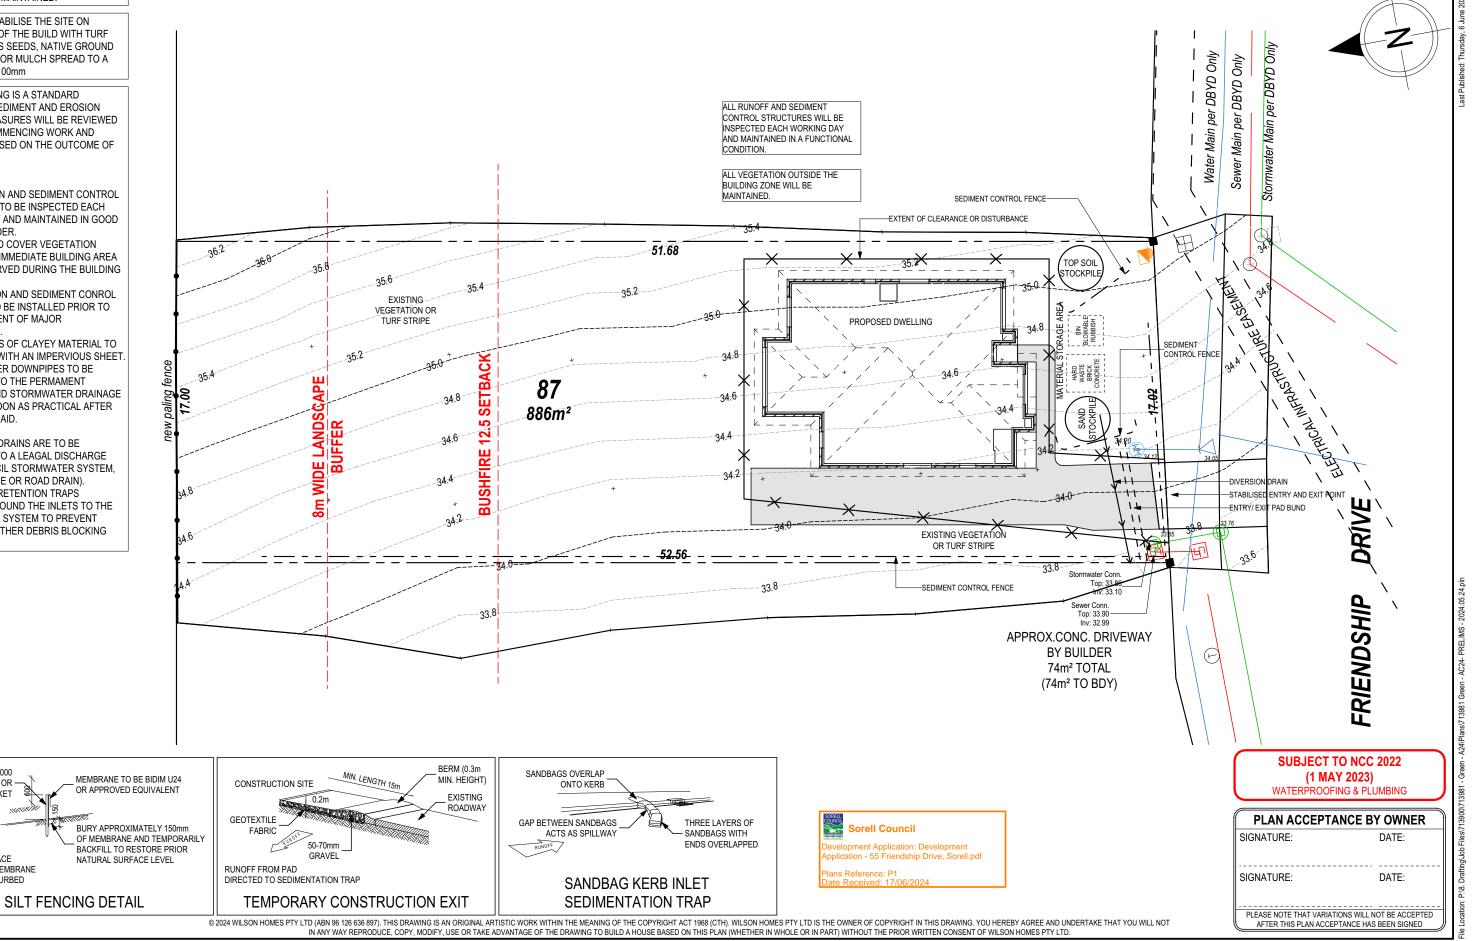



50 x 25 x 1000

STAR PICKET

DOWNHILL OF MEMBRANE

NOT TO BE DISTURBED

STAKE OR

		IN ANT WAT INCH RODGOL, GOT 1, WOODII 1, GOL ON TAINL ADVA	WIAGE OF THE	EDITAMINO TO BOILD A TIOGGE BACED ON THIS FEAR (WHETHER IN WHOLE OR IN TART) WITHOUT THE FRIOR WRITTEN OF	ONGENT OF WILDON HOMEST IT ETD.			征
	SPECIFICATION:	REVISION	DRAWN	CLIENT:	HOUSE DESIGN:	HOUSE CODE:	DO NOT SCALE DRAWINGS, USE	
n	DISCOVERY	1 QUOTE SITING PLAN JOL	23/01/2024	JYE GREEN	EDEN 13	H-WDCEDE10SA	FIGURED DIMENSIONS ONLY. CHECK AND VERIFY DIMENSIONS AND LEVELS PRIOR TO THE	.033
UII	COPYRIGHT:		09/05/2024		FACADE DESIGN:		COMMENCEMENT OF ANY WORK. ALL	n: 24
\bigcirc	© 2024	3 PRELIM PLANS- INITIAL ISSUE RT2	06/06/2024	55 FRIENDSHIP DRIVE, SORELL TAS 7172	NEWPORT	F-WDCEDE10NWPTA	DISCREPANCIES TO BE REPORTED TO THE DRAFTING OFFICE.	/ersic
9				LOT / SECTION / CT: COUNCIL:	SHEET TITLE: SHEET No.:	SCALES:	712001	late)
				87 / - / 185351 SORELL COUNCIL	SOIL & WATER MANAGEMENT PLAN 3 / 13		713981	Lemp

REFER TO SHEET 1 (COVER SHEET) FOR ALL BUILDING INFORMATION REGARDING SUSTAINABILITY REQUIREMENTS

GENERAL BUILDING INFORMATION ALL MECHANICAL VENTILATION TO BE

DISCHARGED TO OUTDOOR AIR AS PER NCC 2022 REQUIREMENTS


FIRE RESISTANT PLASTERBOARD TO BE INSTALLED BEHIND COOKTOP

ALL GROUND FLOOR BULKHEAD AND SQUARE SET OPENING FRAMES TO BE 2155 ABOVE FFL UNLESS NOTED OTHERWISE

REFER TO WINDOW AND DOOR SCHEDULES FOR FULL DETAILS OF ALL WINDOWS AND DOORS. PLEASE NOTE WINDOW AND DOOR SIZES ARE BASED ON MANUFACTURERS SPECIFICATIONS AT DEPOSIT STAGE AND MAY DIFFER SLIGHTLY TO THE SIZES NOMINATED IN THE SCOPE OF WORKS DUE TO MANUFACTURING CHANGES AT THE TIME OF CONSTRUCTION

FINAL WINDOW AND EXTERIOR DOOR LOCATIONS MAY BE ADJUSTED ON SITE TO SUIT BRICKWORK GAUGE

LINI ESS NOTED OTHERWISE ALL ROOMS ARE REFERENCED AS FOLLOWS:

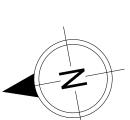



HS / WS HOB SPOUT / WALL SPOUT FACE BRICK / COMMON BRICK

SOUND INSULATION

BRICK ARTICULATION JOINT A.I

SDP STANDARD DOWNPIPE CDP CHARGED DOWNPIPE

RENDER

3D

L.B.W

M MECHANICAL VENTILATION

DENOTES DRAWER SIDE

LOAD BEARING WALL

РВ PLASTERBOARD

FC FIBRE CEMENT

I),

THIS DOOR OPENS FIRST SMOKE ALARM

LIFT OFF HINGE


+ WATER POINT

GAS BAYONET

MAIN DWELLING, GROUND FLOOR

122.28 LIVING PORCH 1.01 123.29 m² ANY PART OF THE FASCIA, GUTTERING OR DOWNPIPE THAT IS WITHIN 450mm OF ANY BOUNDARY IS TO BE NON-COMBUSTIBLE IN ACCORDANCE WITH NCC 2022

ALL EXTERIOR SLABS TO BE GRADED BY CONCRETER TO ACHIEVE APPROX. 1:100 FALL TO OUTSIDE EDGE WITH MAXIMUM CROSSFALL OF 30mm OVER ENTIRE SLAB.

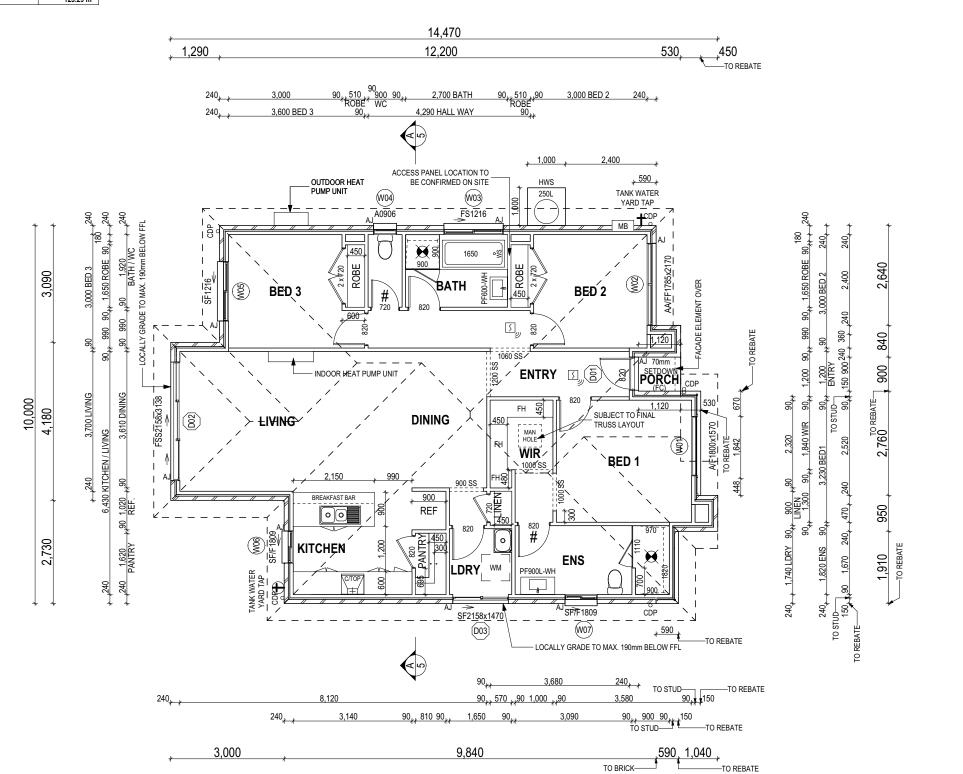

ALL [

© 2024 WILSON HOMES PTY LTD (ABN 96 126 636 897). THIS DRAWING IS AN ORIGINAL ARTISTIC WORK WITHIN THE MEANING OF THE COPYRIGHT ACT 1968 (CTH). WILSON HOMES PTY LTD IS THE OWNER OF COPYRIGHT IN THIS DRAWING. YOU HEREBY AGREE AND UNDERTAKE THAT YOU WILL NOT

DIMENSIONS ARE FRAME DIMENSIONS	

PLAN ACCEPTAN	CE BY OWNER	7136
SIGNATURE:	DATE:	Drafting\Job Files\7136
SIGNATURE:	DATE:	P:\8
PLEASE NOTE THAT VARIATION AFTER THIS PLAN ACCEPTA		File Location:

SUBJECT TO NCC 2022

(1 MAY 2023)

WATERPROOFING & PLUMBING


DLAN ACCEPTANCE BY OWNED

Sorell Council

plication - 55 Friendship Drive, Sorell.pdf



	IN ANY WAY REPRODUCE, COPY, MODIFY, USE OR 1	KE ADVANTAGE OF THE	E DRAWING TO BUILD A HOUSE BASED ON THIS PLAN (WHETHER IN WHOLE OR IN PART) WITHOU	THE PRIOR WRITTEN CONSENT OF WILSON HOMES PTY LTD.			
SPECIFICATION:	REVISION	DRAWN	CLIENT:	HOUSE DESIGN:		HOUSE CODE:	DO NOT SCALE DRAWINGS, USE
DISCOVERY	1 QUOTE SITING PLAN	JOL 23/01/2024	JYE GREEN	EDEN 13		H-WDCEDE10SA	FIGURED DIMENSIONS ONLY. CHECK AND VERIFY DIMENSIONS AND
COPYRIGHT:	2 DRAFT SALES PLAN- CT-1, CONTOUR UPDATE	RT2 09/05/2024	ADDRESS:	FACADE DESIGN:		FACADE CODE:	LEVELS PRIOR TO THE COMMENCEMENT OF ANY WORK. ALL
© 2024	3 PRELIM PLANS- INITIAL ISSUE	RT2 06/06/2024	55 FRIENDSHIP DRIVE, SORELL TAS 7172	NEWPORT		F-WDCEDE10NWPTA	DISCREPANCIES TO BE REPORTED TO THE DRAFTING OFFICE.
		<u> </u>	LOT / SECTION / CT: COUNCIL:	SHEET TITLE:	SHEET No.:	SCALES:	742004
			87 / - / 185351 SORELL COUNCIL	GROUND FLOOR PLAN	4 / 13	1:100	713981

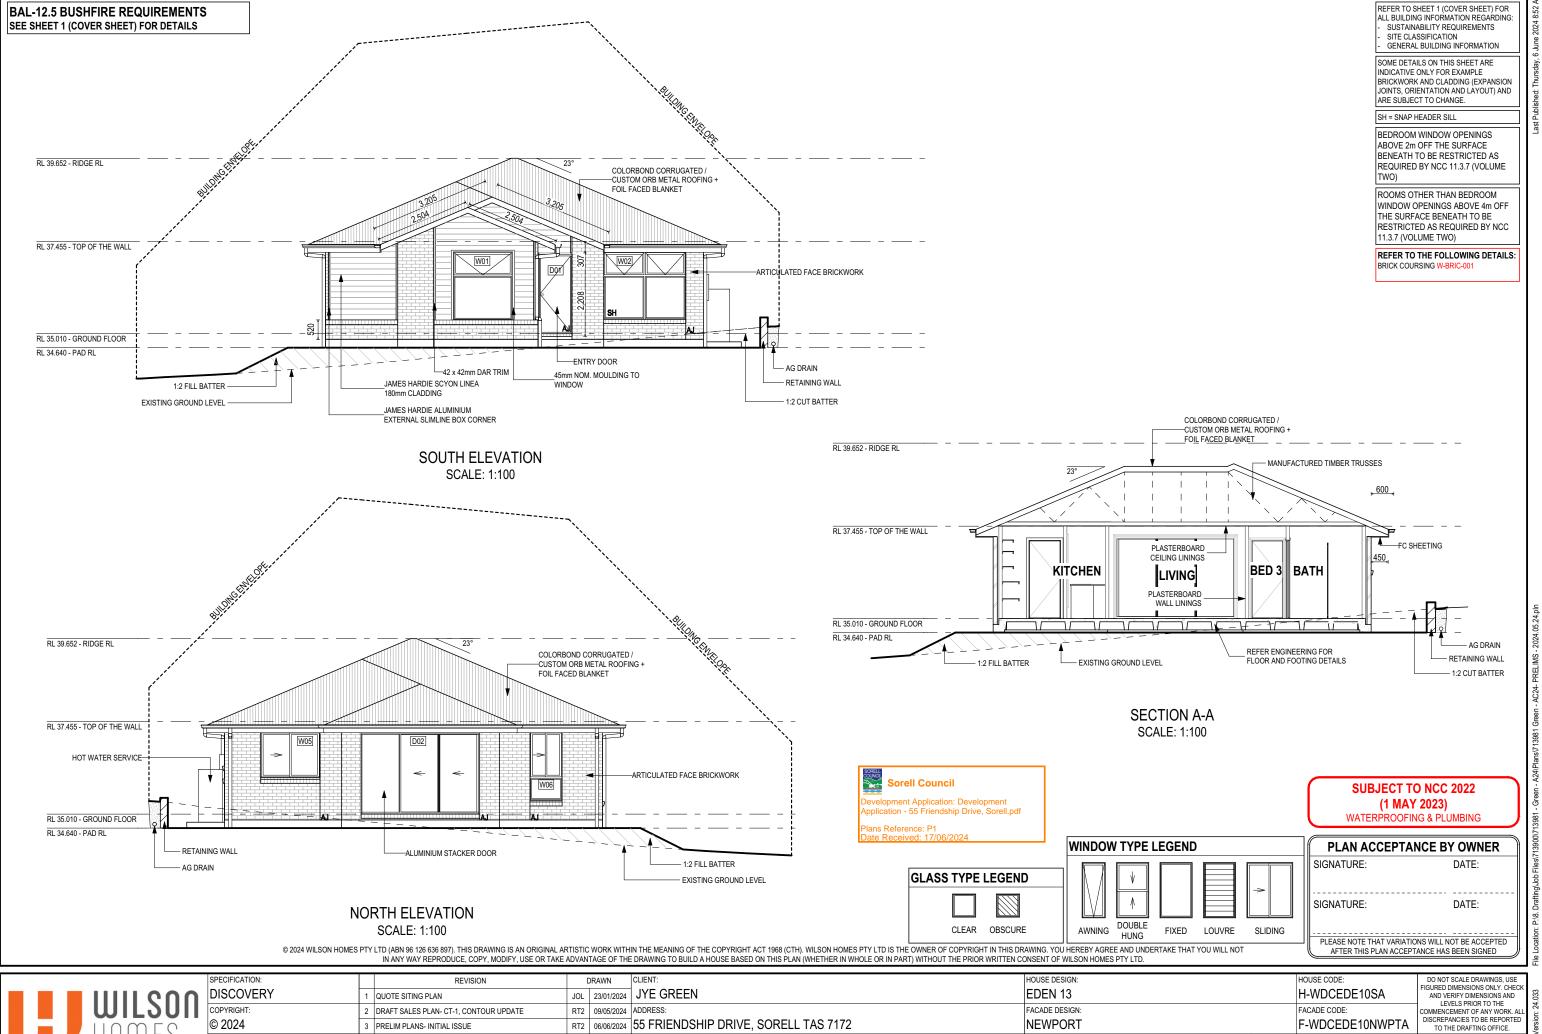

SORELL COUNCIL

LOT / SECTION / CT:

87 / - / 185351

SHEET TITLE:

ELEVATIONS / SECTION

SHEET No.: SCALES:

1:100

5 / 13

713981

COUNCIL:

SORELL COUNCIL

LOT / SECTION / CT:

87 / - / 185351

SHEET TITLE:

ELEVATIONS

SHEET No.: SCALES:

1:100

6 / 13

Template Version: 24.033

713981

EXTERIOR WIND	OOW & DOOR SCHEDUL	E 1,2 ASSUME LOOKI	ING FROM OUTSIDE									
STOREY	ID CODE¹	TYPE	ROOM	HEIGHT	WIDTH PERIMETER	AREA FRAME (m²) TYPE	BAL RATING	SILL TYPE	ORIENT.	GLAZING AREA (m²)	GLAZING TYPE (SINGLE GLAZING U.N.O.)	ADDITIONAL INFORMATION ²
WINDOW		·	·									
GROUND FLOOR	W01 A/F1800x1570	SPECIAL	BED 1	1,800	1,570 6,740	2.83 ALUMINIUM	BAL-12.5	NONE	S	2.37	CLEAR	BP 1170
GROUND FLOOR	W02 AA/FF1785x2170	SPECIAL	BED 2	1,785	2,170 7,910	3.87 ALUMINIUM	BAL-12.5	SNAP HEADER	S	3.16	CLEAR	BP 1160, MP 1085/1085
GROUND FLOOR	W03 FS1216	SLIDING	BATH	1,200	1,570 5,540	1.88 ALUMINIUM	BAL-12.5	ANGLED	Е	1.64	OBSCURE, TOUGHENED	
GROUND FLOOR	W04 A0906	AWNING	WC	860	610 2,940	0.52 ALUMINIUM	BAL-12.5	ANGLED	E	0.35	OBSCURE, TOUGHENED	
GROUND FLOOR	W05 SF1216	SLIDING	BED 3	1,200	1,570 5,540	1.88 ALUMINIUM	BAL-12.5	ANGLED	N	1.64	CLEAR	
GROUND FLOOR	W06 SF/F1809	SLIDING	KITCHEN	1,800	850 5,300	1.53 ALUMINIUM	BAL-12.5	ANGLED	N	1.24	CLEAR	BP 600
GROUND FLOOR	W07 SF/F1809	SLIDING	ENS	1,800	850 5,300	1.53 ALUMINIUM	BAL-12.5	ANGLED	W	1.24	OBSCURE, TOUGHENED	BP 600
						14.04				11.64		
DOOR												
GROUND FLOOR	D01 820	SWINGING	ENTRY	2,097	876 5,946	1.84 ALUMINIUM	BAL-12.5	SNAP HEADER	S	1.23	N\A	
GROUND FLOOR	D02 FSS2158x3138	STACKER	LIVING	2,158	3,138 10,592	6.77 ALUMINIUM	BAL-12.5	SNAP HEADER	N	6.02	CLEAR, TOUGHENED	
GROUND FLOOR	D03 SF2158x1470	SLIDING	LDRY	2,158	1,470 7,256	3.17 ALUMINIUM	BAL-12.5	SNAP HEADER	W	2.71	CLEAR, TOUGHENED	
						11.78				9.96		
						25.82				21.60		

Provide BAL-12.5 rated aluminium windows and external glass sliding doors in lieu

Provide flyscreens with corrosion resistant mesh to all opening window sashes only.

Sorell Council

Development Application: Development Application - 55 Friendship Drive, Sorell.pdf

I١	NTERIOR WIND	OW 8	& DOOR SCHED	ULE					
	STOREY	QTY	CODE	TYPE	HEIGHT	WIDTH	GLAZING TYPE	ADDITIONAL INFORMATION	
D	OOR		•						
	GROUND FLOOR	2	1000 SS	SQUARE SET OPENING	2,155	1,000	N/A		
	GROUND FLOOR	1	1060 SS	SQUARE SET OPENING	2,155	1,060	N/A		
	GROUND FLOOR	1	1200 SS	SQUARE SET OPENING	2,155	1,200	N/A		
	GROUND FLOOR	2	2 x 720	SWINGING	2,040	1,440	N/A		
	GROUND FLOOR	1	720	SWINGING	2,040	720	N/A	LIFT-OFF HINGES	
	GROUND FLOOR	1	720	SWINGING	2,040	720	N/A		
	GROUND FLOOR	6	820	SWINGING	2,040	820	N/A		
	GROUND FLOOR	1	820	SWINGING	2,040	820	N/A	LIFT-OFF HINGES	
	GROUND FLOOR	1	900 SS	SQUARE SET OPENING	2,155	900	N/A		

PICTURE, TV RECESS AND SS WINDOW OPENINGS QTY TYPE HEIGHT WIDTH AREA (m²)

SUSTAINABILITY REQUIREMENTS SITE CLASSIFICATION GENERAL BUILDING INFORMATION

REFER TO SHEET 1 (COVER SHEET) FOR ALL BUILDING INFORMATION REGARDING: SEE SHEET 1 (COVER SHEET) FOR DETAILS

NOTE: INTERNAL DOORS TO WET AREAS WITH MECHANICAL VENTILATION TO BE UNDERCUT 20mm

© 2024 WILSON HOMES PTY LTD (ABN 96 126 636 897). THIS DRAWING IS AN ORIGINAL ARTISTIC WORK WITHIN THE MEANING OF THE COPYRIGHT ACT 1968 (CTH). WILSON HOMES PTY LTD IS THE OWNER OF COPYRIGHT IN THIS DRAWING. YOU HEREBY AGREE AND UNDERTAKE THAT YOU WILL NOT

	WILSON
L	HOMES

	© 2024 WILSON HOWES				THE DRAWING TO BUILD A HOUSE BASED ON THIS PLAN (WHETHER IN WHOLE OR IN PART) WITHOUT THE PRIOR WRITTEN CO		AFTER THIS PLAN ACCEPT.	ANCE HAS BEEN SIGNED
								1
	SPECIFICATION:	REVISION		DRAWN	CLIENT:	HOUSE DESIGN:	HOUSE CODE:	DO NOT SCALE DRAWINGS, USE
1	DISCOVERY	1 QUOTE SITING PLAN	JOL	23/01/2024	JYE GREEN	EDEN 13	H-WDCEDE10SA	FIGURED DIMENSIONS ONLY. CHEC AND VERIFY DIMENSIONS AND LEVELS PRIOR TO THE
	COPYRIGHT:	2 DRAFT SALES PLAN- CT-1, CONTOUR UPDATE	RT2	09/05/2024	ADDRESS:	FACADE DESIGN:	FACADE CODE:	COMMENCEMENT OF ANY WORK. A
•	© 2024	3 PRELIM PLANS- INITIAL ISSUE	RT2	06/06/2024	55 FRIENDSHIP DRIVE, SORELL TAS 7172	NEWPORT	F-WDCEDE10NWPTA	DISCREPANCIES TO BE REPORTED TO THE DRAFTING OFFICE.
					LOT / SECTION / CT: COUNCIL:	SHEET TITLE: SHEET No.:	SCALES:	742004
					87 / - / 185351 SORELL COUNCIL	WINDOW & DOOR SCHEDULES 7 / 13		713981

Manufacturer - Clark Windows			
Window Type	Glazing	U-Value	SHGC
Awning	Single	6.5	0.67
	Double	4.1	0.57
Fixed	Single	5.9	0.75
	Double	3.2	0.67
Sliding	Single	6.4	0.76
	Double	4.2	0.59
Fixed Pane	Single	5.9	0.75
	Double	3.2	0.67
Fixed Glass Panel Hinged Door	Single	6.0	0.62
	Double	4.3	0.55
Sliding Door	Single	6.1	0.74
	Double	3.6	0.66
Stacking Door	Single	6.3	0.74
	Double	3.8	0.66
135 deg. Awning Bay Window	Single	6.5	0.67
	Double	4.1	0.57
135 deg. Sliding Bay Window	Single	6.5	0.76
	Double	4.2	0.59
90 deg. Awning Bay Window	Single	6.5	0.67
	Double	4.1	0.57
90 deg. Sliding Bay Window	Single	6.5	0.76
	Double	4.2	0.59
Bifold Doors	Single	6.1	0.61
	Double	4.4	0.53

NOTE:
Windows supplied MUST HAVE Uw better and or equal to stated figures and SHGC within +/- 5% of stated figures. Restricted windows to have their openability restricted as per N.C.C 11.3.6.

> **SUBJECT TO NCC 2022** (1 MAY 2023) WATERPROOFING & PLUMBING


PLAN ACCEPTAN	CE BY OWNER
SIGNATURE:	DATE:
SIGNATURE:	DATE:

PLEASE NOTE THAT VARIATIONS WILL NOT BE ACCEPTED

AFTER THIS PLAN ACCEPTANCE HAS BEEN SIGNED

S, USE C CHECK S AND

_{*} 1,290 _{*} 12,450

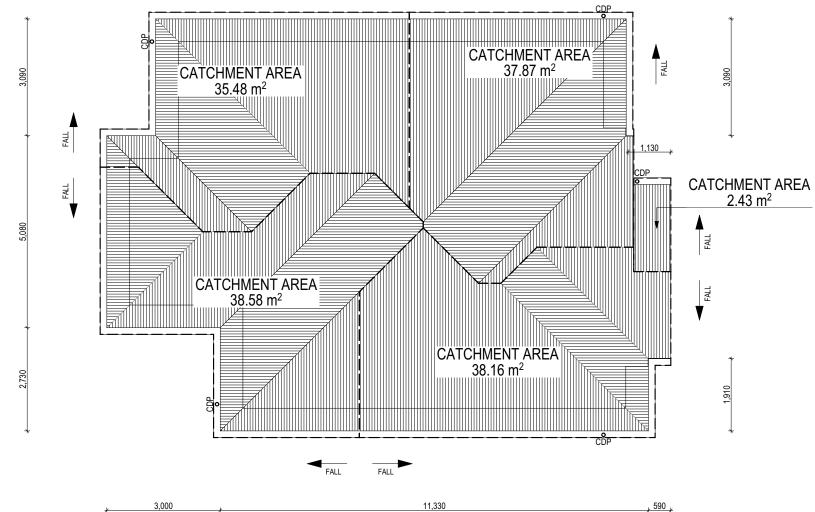

WHERE DOWNPIPES ARE FURTHER THAN 1.2m AWAY FROM VALLEY REFER TO N.C.C. 7.3.5(2)

POSITION AND QUALITY OF DOWNPIPES
ARE NOT TO BE ALTERED WITHOUT CONSULTATION WITH DESIGNER.

AREA'S SHOWN ARE SURFACE AREAS/ CATCHMENT AREAS, NOT PLAN AREAS

Roofi	ng Data	
	144.41	Flat Roof Area (excluding gutter and slope factor) (m²)
	157.23	Roof Surface Area (includes slope factor, excludes gutter) (m²)
Dowr	pipe roof	calculations (as per AS/NZA3500.3:2018)
Ah	152.52	Area of roof catchment (including 115mm Slotted Quad Gutter) (m²)
Ac	184.55	Ah x Catchment Area Multiplier for slope (Table 3.4.3.2 from AS/NZS 3500.3:2018) (1.21 for 23° pitch) (m²)
Ae	6300	Cross sectional area of 57 x 115 Slotted Quad Gutter (mm²)
DRI	86	Design Rainfall Intensity (determined from Table E1 from AS/NZS 3500.3:2018)
Acdp	64	Catchment area per Downpipe (determined from Figure 3.5(A) from AS/NZS 3500.3:2018) (m²)
Required Downpipes	2.9	Ac / Acdp
Downpipes Provided	5	



SOFFIT EAVE VENT PROPOSED LOCATION TO BE MIN. 1M FROM CORNER JOINT

SUBJECT TO NCC 2022 (1 MAY 2023) WATERPROOFING & PLUMBING

PLAN ACCEPTA	ANCE BY OWNER
SIGNATURE:	DATE:
SIGNATURE:	DATE:
	TIONS WILL NOT BE ACCEPTED

© 2024 WILSON HOMES PTY LTD (ABN 96 126 636 897). THIS DRAWING IS AN ORIGINAL ARTISTIC WORK WITHIN THE MEANING OF THE COPYRIGHT ACT 1968 (CTH), WILSON HOMES PTY LTD IS THE OWNER OF COPYRIGHT IN THIS DRAWING. YOU HEREBY AGREE AND UNDERTAKE THAT YOU WILL NOT IN ANY WAY REPRODUCE, COPY, MODIFY, USE OR TAKE ADVANTAGE OF THE DRAWING TO BUILD A HOUSE BASED ON THIS PLAN (WHETHER IN WHOLE OR IN PART) WITHOUT THE PRIOR WRITTEN CONSENT OF WILSON HOMES PTY LTD.

WILSON
HOMES

		INTERNATION INC.	JV/III/I/IOE)	BIG WIITO TO BOILD WITOGOL BROLD O	THE TEST EST (MILETIZE TO THE THOSE OF THE THOSE	· WINTITE IN OC	SHOERT OF THEODITIONEOF IT ETD.				证
	SPECIFICATION:	REVISION	DRAWN		CLIENT:			HOUSE DESIGN:		HOUSE CODE:	DO NOT SCALE DRAWINGS, USE	i
n	DISCOVERY 1	QUOTE SITING PLAN	JOL 23/01	/2024	JYE GREEN			EDEN 13		H-WDCEDE10SA	FIGURED DIMENSIONS ONLY. CHECK AND VERIFY DIMENSIONS AND LEVELS PRIOR TO THE	1.033
		, , , , , , , , , , , , , , , , , , , ,	RT2 09/05					FACADE DESIGN:			COMMENCEMENT OF ANY WORK. ALL DISCREPANCIES TO BE REPORTED	
	© 2024	PRELIM PLANS- INITIAL ISSUE	RT2 06/06	/2024	55 FRIENDSHIP DRIVE, S	SORELL TAS 7172		NEWPORT		F-WDCEDE10NWPTA	TO THE DRAFTING OFFICE.	Versi
						COUNCIL:		SHEET TITLE:	SHEET No.:	SCALES:	713981	olate
				3	37 / - / 185351	SORELL COUNCIL		ROOF DRAINAGE PLAN	8 / 13		113901	Lemb

GENERAL BUILDING INFORMATION

FLOOR TILES SHOWN ON PLAN DO NOT INDICATE THE SIZE OR JOINT LOCATIONS OF THE ACTUAL FLOOR TILES.
TIMBER FLOORING SHOWN ON PLAN DOES NOT INDICATE THE BOARD SIZE OR DIRECTION OF THE ACTUAL FLOORING.

COVERINGS LEGEND

NO COVERING


COVER GRADE CONCRETE

CARPET

LAMINATE

TILE (STANDARD WET AREAS)

TILE (UPGRADED AREAS)

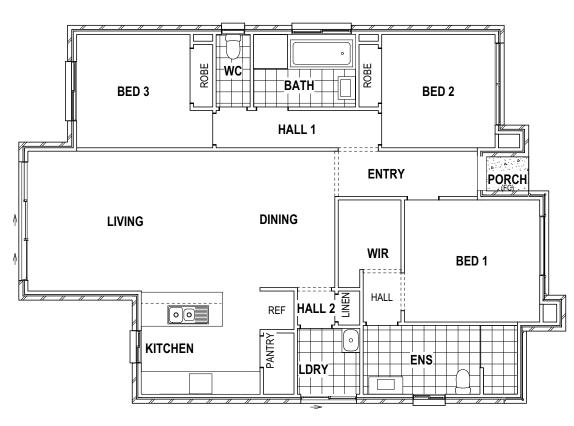

FLOOR COVERINGS SCALE: 1:100



BAL-12.5 BUSHFIRE REQUIREMENTS SEE SHEET 1 (COVER SHEET) FOR DETAILS

© 2024 WILSON HOMES PTY LTD (ABN 96 126 636 897). THIS DRAWING IS AN ORIGINAL ARTISTIC WORK WITHIN THE MEANING OF THE COPYRIGHT ACT 1968 (CTH). WILSON HOMES PTY LTD IS THE OWNER OF COPYRIGHT IN THIS DRAWING. YOU HEREBY AGREE AND UNDERTAKE THAT YOU WILL NOT

SORELL COUNCIL

HOMES © 2022	IJ	WILSON HOMES	DISCOV COPYRIGHT: © 2024
--------------	----	-----------------	--------------------------------

IN ANY WAY REPRODUCE, COPY, MODIFY, USE OR TAKE ADVANTAGE OF THE DRAWING TO BUILD A HOUSE BASED ON THIS PLAN (WHETHER IN WHOLE OR IN PART) WITHOUT THE PRIOR WRITTEN CONSENT OF WILSON HOMES PTY LTD.								
SPECIFICATION:	REVISION	DRAWN	CLIENT:	HOUSE DESIGN:				
DISCOVERY	1 QUOTE SITING PLAN	JOL 23/01/2024	JYE GREEN	EDEN 13				

RT2 06/06/2024 55 FRIENDSHIP DRIVE, SORELL TAS 7172

LOT / SECTION / CT:

87 / - / 185351

RT2 09/05/2024 ADDRESS:

2 DRAFT SALES PLAN- CT-1, CONTOUR UPDATE

3 PRELIM PLANS- INITIAL ISSUE

		PLEASE NOTE THAT VARIATIO AFTER THIS PLAN ACCEPT.	
		HOUSE CODE:	DO NOT SCALE DRAWINGS, US
		H-WDCEDE10SA	FIGURED DIMENSIONS ONLY. CHI AND VERIFY DIMENSIONS AND
_		FACADE CODE:	LEVELS PRIOR TO THE COMMENCEMENT OF ANY WORK.
		F-WDCEDE10NWPTA	DISCREPANCIES TO BE REPORT
		F-WDCEDE IUNWFIA	TO THE DRAFTING OFFICE.
	SHEET No.:	SCALES:	742004
	9 / 13	1:100	713981

DATE:

DATE:

SIGNATURE:

SIGNATURE:

FACADE DESIGN:

NEWPORT

FLOOR COVERINGS

SHEET TITLE:


SCALE: 1:50

OVEN


DWS

ELEVATION A


SCALE: 1:50

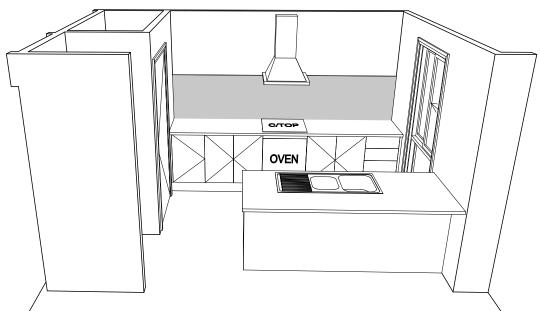


REF SPACE

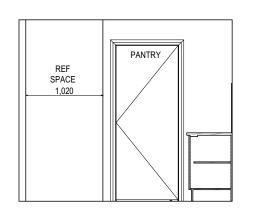

ELEVATION B SCALE: 1:50

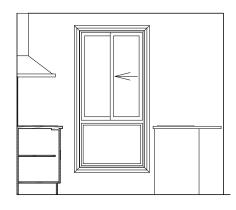


ELEVATION D SCALE: 1:50

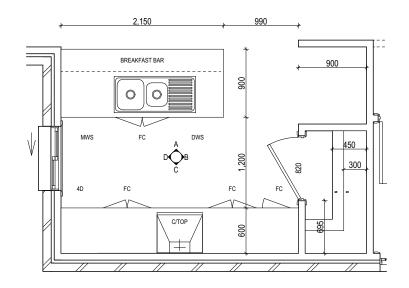

KITCHEN PLAN SCALE: 1:50



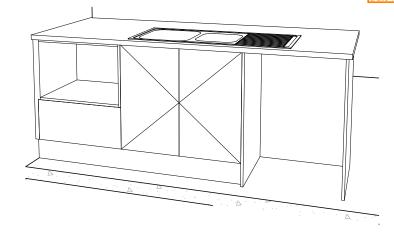

REFER TO SHEET 1 (COVER SHEET) FOR ALL BUILDING INFORMATION REGARDING:

SUSTAINABILITY REQUIREMENTS SITE CLASSIFICATION GENERAL BUILDING INFORMATION DETAILS DEPICTED ON THIS SHEET ARE A REPRESENTATION ONLY. JOINER MAY ADJUST CABINETRY AS REQUIRED.

WATERPROOFING & PLUMBING

PLAN ACCEPTANCE BY OWNER SIGNATURE: DATE: SIGNATURE: DATE: PLEASE NOTE THAT VARIATIONS WILL NOT BE ACCEPTED AFTER THIS PLAN ACCEPTANCE HAS BEEN SIGNED

ALL DIMENSIONS ARE FRAME DIMENSIONS


© 2024 WILSON HOMES PTY LTD (ABN 96 126 636 897). THIS DRAWING IS AN ORIGINAL ARTISTIC WORK WITHIN THE MEANING OF THE COPYRIGHT ACT 1968 (CTH). WILSON HOMES PTY LTD IS THE OWNER OF COPYRIGHT IN THIS DRAWING, YOU HEREBY AGREE AND UNDERTAKE THAT YOU WILL NOT

Г		s
	WILSON	
		0
	HOMES	
ı	HOHILO	

VI - I V	010110	IN ANT WAT REPRODUCE, COPT, MODIFT, USE OR TAKE	ADVAN	TAGE OF TH	E DRAWING TO BUILD A HOUSE BASED (ON THIS PLAN (WHETHER IN WHOLE OR IN PART) WITHOUT THE PRIOR WRITTEN	CONSENT OF WILSON HOMES PTT LTD.				iĒ
	SPECIFICATION:	REVISION		DRAWN	CLIENT:		HOUSE DESIGN:		HOUSE CODE:	DO NOT SCALE DRAWINGS, USE]
\cap	DISCOVERY	1 QUOTE SITING PLAN	JOL	23/01/2024	JYE GREEN		EDEN 13		H-WDCEDE10SA	FIGURED DIMENSIONS ONLY. CHECK AND VERIFY DIMENSIONS AND LEVELS PRIOR TO THE	.033
Ш	COPYRIGHT:	2 DRAFT SALES PLAN- CT-1, CONTOUR UPDATE			ADDRESS:		FACADE DESIGN:		FACADE CODE:	COMMENCEMENT OF ANY WORK. ALL	
	© 2024	3 PRELIM PLANS- INITIAL ISSUE	RT2	06/06/2024	55 FRIENDSHIP DRIVE,	SORELL TAS 7172	NEWPORT		F-WDCEDE10NWPTA	DISCREPANCIES TO BE REPORTED TO THE DRAFTING OFFICE.	Versic
					LOT / SECTION / CT:	COUNCIL:	SHEET TITLE:	SHEET No.:		713981	late '
					87 / - / 185351	SORELL COUNCIL	KITCHEN DETAILS	10 / 13	1:50	113901	Temp

LEGEND

DETAILS DEPICTED ON THIS SHEET ARE A REPRESENTATION ONLY

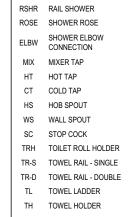

TR TOWEL RACK TMB TUMBLER HOLDER RNG TOWEL RING RH ROBE HOOK SHLF SHELF SR SHAMPOO RECESS

SOAP SOAP HOLDER

ACCESS PANEL LOCATION TO BE CONFIRMED ON SITE

BATHROOM PLAN SCALE: 1:50

	HEIGHT 446mm								
548mm	446mm								
378mm	446mm								
1578mm	446mm								
III.ZZIOIIII GOGALGOOIIIII GOGAIIII									


FURTHER DETAIL PRIOR TO INSTALLATION.

SUBJECT TO NCC 2022 (1 MAY 2023) WATERPROOFING & PLUMBING

PLAN ACCEPTA	NCE BY OWNER
SIGNATURE:	DATE:
SIGNATURE:	DATE:


PLEASE NOTE THAT VARIATIONS WILL NOT BE ACCEPTED AFTER THIS PLAN ACCEPTANCE HAS BEEN SIGNED

ELEVATION A SCALE: 1:50

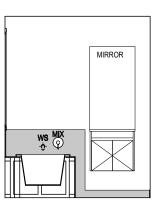


ELEVATION B SCALE: 1:50



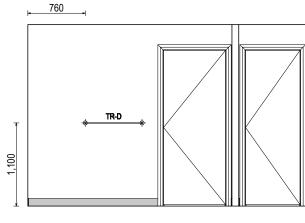

ELEVATION C SCALE: 1:50

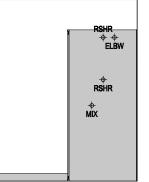

ELEVATION D SCALE: 1:50

ALL DIMENSIONS ARE FRAME DIMENSIONS

© 2024 WILSON HOMES PTY LTD (ABN 96 126 636 897). THIS DRAWING IS AN ORIGINAL ARTISTIC WORK WITHIN THE MEANING OF THE COPYRIGHT ACT 1968 (CTH). WILSON HOMES PTY LTD IS THE OWNER OF COPYRIGHT IN THIS DRAWING. YOU HEREBY AGREE AND UNDERTAKE THAT YOU WILL NOT IN ANY WAY REPRODUCE. COPY MODIEY LISE OR TAKE ADVANTAGE OF THE DRAWING TO BIJLID A HOUSE RASED ON THIS PLAN (WHETHER IN WHOLE OR IN PART) WITHOUT THE PRIOR WRITTEN CONSENT OF WILSON HOMES PTY LTD.


	SP
WILSON	D cc ©
mir9011	CC
IIOMFO	©
HUIIIFS	

	IN ART MATERIA ROUGE, GOTT, MODILIT, GOT ON TAKE ADVANTAGE OF THE DIVANTAGE OF THE DAY MATERIAL WINDS THE PROPERTY OF THE PROP						证	
SPECIFICATION:	REVISION	DRAWN CLIENT:		HOUSE DESIGN:		HOUSE CODE:	DO NOT SCALE DRAWINGS, USE	
DISCOVERY	1 QUOTE SITING PLAN	JOL 23/01/2024 JYE GREEN		EDEN 13	EDEN 13		FIGURED DIMENSIONS ONLY. CHECK AND VERIFY DIMENSIONS AND	.033
COPYRIGHT:	2 DRAFT SALES PLAN- CT-1, CONTOUR UPDATE	RT2 09/05/2024 ADDRESS:		FACADE DESIGN:			LEVELS PRIOR TO THE COMMENCEMENT OF ANY WORK. ALL	nr: 24
© 2024	3 PRELIM PLANS- INITIAL ISSUE	RT2 06/06/2024 55 FRIENDSHIP DF	RIVE, SORELL TAS 7172	NEWPORT		F-WDCEDE10NWPTA	DISCREPANCIES TO BE REPORTED TO THE DRAFTING OFFICE.	/ersic
		LOT / SECTION / CT:	COUNCIL:	SHEET TITLE:	SHEET No.:		712001	late
		87 / - / 185351	SORELL COUNCIL	BATHROOM DETAILS	11 / 13	1:50	713981	Гетр

REFER TO THE FOLLOWING DETAILS: VANITY DETAILS G-VANI-001
WINDOW OVER BATH HOB D-WIND-ALU001 STANDARD BATH HOB D-WETA-BATH003
WET AREA TILING LAYOUTS D-WETA-TILE002 SQUARE SET WINDOWS G-WIND-SSET02 FULL HEIGHT TILING D-LINI-WETA


REFER TO SHEET 1 (COVER SHEET) FOR ALL BUILDING INFORMATION REGARDING: SUSTAINABILITY REQUIREMENTS SITE CLASSIFICATION GENERAL BUILDING INFORMATION

DETAILS DEPICTED ON THIS SHEET ARE A REPRESENTATION ONLY

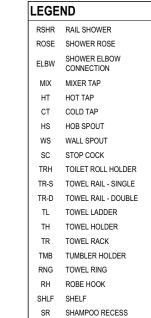


SOAP SOAP HOLDER


Sorell Council velopment Application: Development olication - 55 Friendship Drive, Sorell.pdf

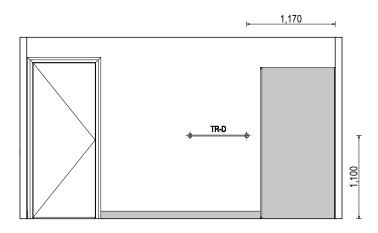


ELEVATION A SCALE: 1:50

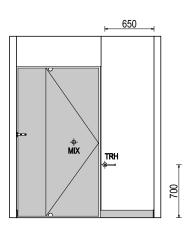


ELEVATION B SCALE: 1:50

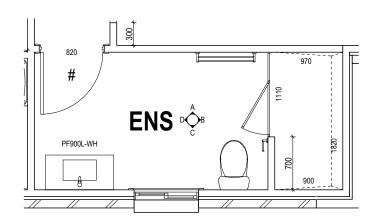

ENSUITE PLAN SCALE: 1:50

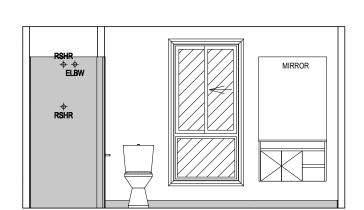

ELEVATION C SCALE: 1:50

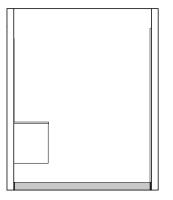

ELEVATION D SCALE: 1:50

					П	
	SHAMPOO	RECESS SIZE	STRUCTURAL DIMENSIONS			
			WIDTH	HEIGHT		
1	"SMALL"	470 x 380mm	548mm	446mm	I.	
	"MEDIUM"	800 x 380mm	878mm	446mm	ŀ	
	"LARGE"	1500 x 380mm	1578mm	446mm		
REFER WILSON HOMES' DETAIL G-WETA-TILEO1 FOR						

REFER WILSON HOMES' DETAIL G-WETA-TILE01 FURTHER DETAIL PRIOR TO INSTALLATION.

SUBJECT TO NCC 2022 (1 MAY 2023)

WATERPROOFING & PLUMBING

PLAN ACCEPTANCE BY OWNER						
SIGNATURE: DATE:						
SIGNATURE:	DATE:					
PLEASE NOTE THAT VARIATIONS WILL NOT BE ACCEPTED AFTER THIS PLAN ACCEPTANCE HAS BEEN SIGNED						

ALL DIMENSIONS ARE FRAME DIMENSIONS


© 2024 WILSON HOMES PTY LTD (ABN 96 126 636 897). THIS DRAWING IS AN ORIGINAL ARTISTIC WORK WITHIN THE MEANING OF THE COPYRIGHT ACT 1968 (CTH). WILSON HOMES PTY LTD IS THE OWNER OF COPYRIGHT IN THIS DRAWING. YOU HEREBY AGREE AND UNDERTAKE THAT YOU WILL NOT IN ANY WAY REPRODUCE. COPY MODIEY LISE OR TAKE ADVANTAGE OF THE DRAWING TO BIJL DA HOLISE RASED ON THIS PLAN (WHETHER IN WHOLE OR IN PART) WITHOUT THE PRIOR WRITTEN CONSENT OF WILSON HOMES PTY LTD.

WILSO	
-------	--


	INVITATION TO THE PROPERTY OF	IN ANT WAT THE ROUDDIE, OUT 1, HIGHER 1, OUZ ON TAKE ADVANTAGE OF THE DISTANTING TO BOILD AT HOUSE DATED ON THE HIGHER WHOLE ON THE THE WHOLE ON THE						正
SPECIFICATION:	REVISION	DRAWN CLIENT:		HOUSE DESIGN:		HOUSE CODE:	DO NOT SCALE DRAWINGS, USE	i
DISCOVERY	1 QUOTE SITING PLAN	JOL 23/01/2024 JYE GREEN		EDEN 13	EDEN 13		FIGURED DIMENSIONS ONLY. CHECK AND VERIFY DIMENSIONS AND	.033
COPYRIGHT:	2 DRAFT SALES PLAN- CT-1, CONTOUR UPDATE	RT2 09/05/2024 ADDRESS:		FACADE DESIGN:			LEVELS PRIOR TO THE COMMENCEMENT OF ANY WORK. ALL	on: 24
© 2024	3 PRELIM PLANS- INITIAL ISSUE	RT2 06/06/2024 55 FRIENDSHIP DF	RIVE, SORELL TAS 7172	NEWPORT		F-WDCEDE10NWPTA	DISCREPANCIES TO BE REPORTED TO THE DRAFTING OFFICE.	Versic
		LOT / SECTION / CT:	COUNCIL:	SHEET TITLE:	SHEET No.:		712001	ate
		87 / - / 185351	SORELL COUNCIL	ENSUITE DETAILS	12 / 13	1:50	713981	Lemp

- SITE CLASSIFICATION
- GENERAL BUILDING INFORMATION


DETAILS DEPICTED ON THIS SHEET ARE A REPRESENTATION ONLY

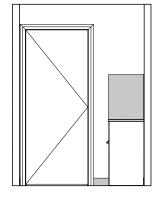


ELEVATION A SCALE: 1:50

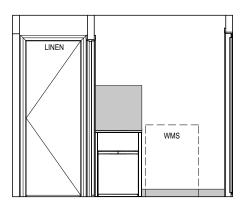


ELEVATION B SCALE: 1:50

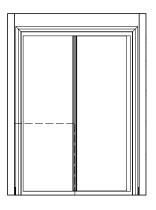

ELEVATION C SCALE: 1:50

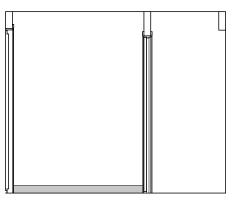

ELEVATION D SCALE: 1:50

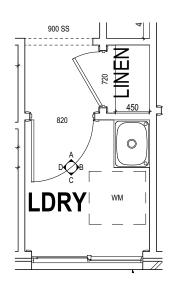

Sorell Council

AUNDRY PLAN SCALE: 1:50

SUBJECT TO NCC 2022 (1 MAY 2023)

WATERPROOFING & PLUMBING

PLAN ACCEPTANCE BY OWNER						
SIGNATURE:	DATE:					
SIGNATURE: DATE:						
PLEASE NOTE THAT VARIATIONS WILL NOT BE ACCEPTED AFTER THIS PLAN ACCEPTANCE HAS BEEN SIGNED						

ALL DIMENSIONS ARE FRAME DIMENSIONS

© 2024 WILSON HOMES PTY LTD (ABN 96 126 636 897). THIS DRAWING IS AN ORIGINAL ARTISTIC WORK WITHIN THE MEANING OF THE COPYRIGHT ACT 1968 (CTH), WILSON HOMES PTY LTD IS THE OWNER OF COPYRIGHT IN THIS DRAWING. YOU HEREBY AGREE AND UNDERTAKE THAT YOU WILL NOT IN ANY WAY REPRODUCE, COPY, MODIFY, USE OR TAKE ADVANTAGE OF THE DRAWING TO BUILD A HOUSE BASED ON THIS PLAN (WHETHER IN WHOLE OR IN PART) WITHOUT THE PRIOR WRITTEN CONSENT OF WILSON HOMES PTY LTD.



		The first of the f						证
SPECIFICATION:	REVISION	DRAWN CLIENT:		HOUSE DESIGN:		HOUSE CODE:	DO NOT SCALE DRAWINGS, USE	
DISCOVERY	1 QUOTE SITING PLAN	JOL 23/01/2024 JYE GREEN		EDEN 13	EDEN 13		FIGURED DIMENSIONS ONLY. CHECK AND VERIFY DIMENSIONS AND LEVELS PRIOR TO THE	1.033
COPYRIGHT:	2 DRAFT SALES PLAN- CT-1, CONTOUR UPDATE	RT2 09/05/2024 ADDRESS:		FACADE DESIGN:			COMMENCEMENT OF ANY WORK. ALL	on: 2
© 2024	3 PRELIM PLANS- INITIAL ISSUE	RT2 06/06/2024 55 FRIENDSHIP DF	RIVE, SORELL TAS 7172	NEWPORT		F-WDCEDE10NWPTA	DISCREPANCIES TO BE REPORTED TO THE DRAFTING OFFICE.	Versi
		LOT / SECTION / CT:	COUNCIL:	SHEET TITLE:	SHEET No.:		713981	late
		87 / - / 185351	SORELL COUNCIL	LAUNDRY DETAILS	13 / 13	1:50	<i>1</i> 13901	e.

ite Version: 24.033 File Location: P:\8. Drafting\Job File