

NOTICE OF PROPOSED DEVELOPMENT

Notice is hereby given that an application has been made for planning approval for the following development:

SITE: 445 Brinktop Road, Penna

PROPOSED DEVELOPMENT: NEW OUTBUILDING INC DEMOLITION OF EXISTING


The relevant plans and documents can be inspected at the Council Offices at 47 Cole Street, Sorell during normal office hours, or the plans may be viewed on Council's website at www.sorell.tas.gov.au until **Monday 5th August 2024.**

Any person may make representation in relation to the proposal by letter or electronic mail (<u>sorell.council@sorell.tas.gov.au</u>) addressed to the General Manager. Representations must be received no later than **Monday 5**th **August 2024.**

APPLICANT: 6ty Pty Ltd

APPLICATION NO: DA 2024 / 145 - 1

DATE: 18 July 2024

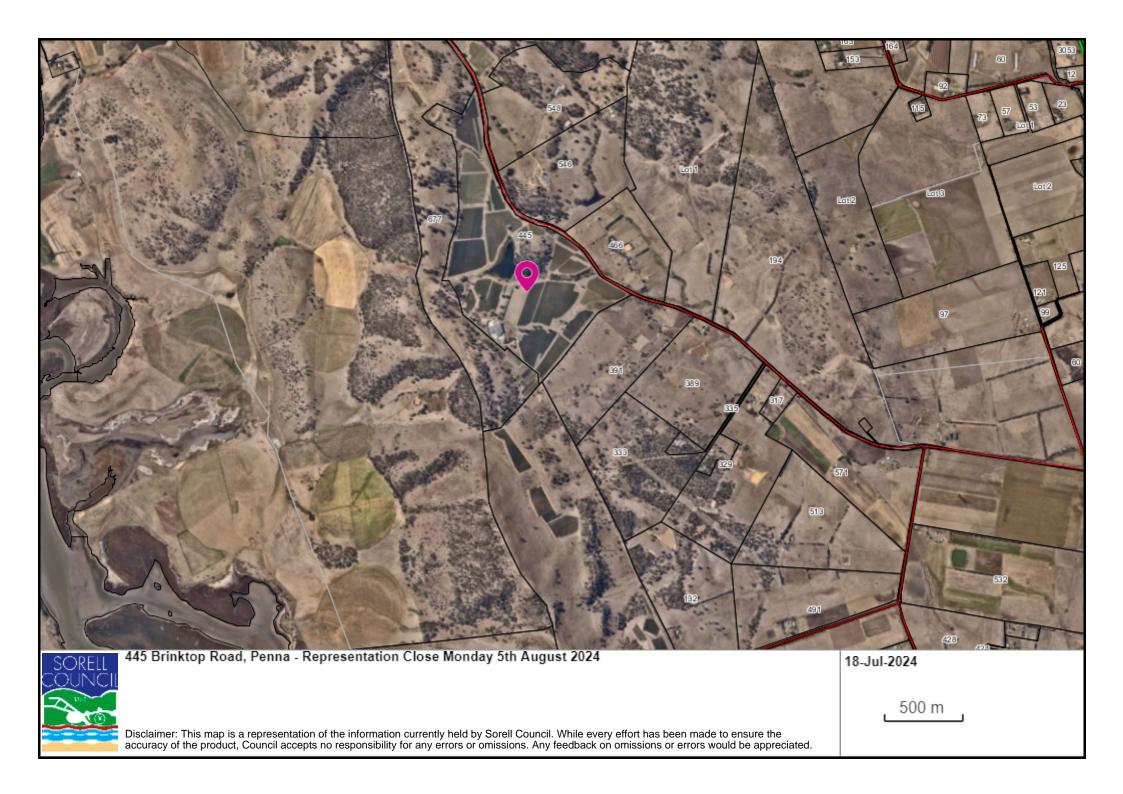

Part B: Please note that Part B of this form is publicly exhibited.

| Full description of Proposal: | Use: | | | |
|--|-------------------------------|----------|---------------|---|
| | Development: | | | |
| | | | | |
| | Large or complex proposals s | hould be | described | in a letter or planning report. |
| Design and cons | struction cost of proposal: | | \$ | |
| le all ar cama th | | | No. \square | Vas. \square |
| is all, or some tr | ne work already constructed: | | No: □ | Yes: □ |
| Location of | | | | |
| proposed | Street address: | | | |
| works: | | | | code: |
| | Certificate of Title(s) Volum | ie: | | FOIIO: |
| | | | | |
| Current Use of Site | | | | |
| | | | | |
| Current Owner/s: | Name(s) | | | |
| | | | | I |
| Is the Property of Register? | on the Tasmanian Heritage | No: □ | Yes: □ | If yes, please provide written advice from Heritage Tasmania |
| Is the proposal than one stage? | to be carried out in more | No: □ | Yes: □ | If yes, please clearly describe in plans |
| Have any potentially contaminating uses been undertaken on the site? | | No: □ | Yes: □ | If yes, please complete the Additional Information for Non-Residential Use |
| Is any vegetation proposed to be removed? | | | Yes: □ | If yes, please ensure plans clearly show area to be impacted |
| Does the proposal involve land administered or owned by either the Crown No: Yes: If yes, please complete the Council or | | | | |
| or Council? | | | | Crown land section on page 3 |
| If a new or upgraded vehicular crossing is required from Council to the front boundary please | | | | |
| complete the Vehicular Crossing (and Associated Works) application form | | | | |
| https://www.sorell.tas.gov.au/services/engineering/ Sorell Council | | | | |
| | | | | Development Application: Development Application - 445 Brinktop Road, Penna.pdf |

Page **2** of **4**

Plans Reference:P1 Date Received:18/06/2024

Declarations and acknowledgements

- I/we confirm that the application does not contradict any easement, covenant or restriction specified in the Certificate of Title, Schedule of Easements or Part 5 Agreement for the land.
- I/we consent to Council employees or consultants entering the site and have arranged permission and/or access for Council's representatives to enter the land at any time during normal business hours.
- I/we authorise the provision of a copy of any documents relating to this application to any person for the purposes of assessment or public consultation and have permission of the copyright owner for such copies.
- I/we declare that, in accordance with s52(1) of the Land Use Planning and Approvals Act 1993, that I have notified the owner(s) of the intention to make this application.
- I/we declare that the information in this application is true and correct.

Details of how the Council manages personal information and how you can request access or corrections to it is outlined in Council's Privacy Policy available on the Council website.

- I/we acknowledge that the documentation submitted in support of my application will become a public record held by Council and may be reproduced by Council in both electronic and hard copy format in order to facilitate the assessment process, for display purposes during public exhibition, and to fulfil its statutory obligations. I further acknowledge that following determination of my application, Council will store documentation relating to my application in electronic format only.
- Where the General Manager's consent is also required under s.14 of the *Urban Drainage Act 2013*, by making this application I/we also apply for that consent.

| Applicant Signature: | Signature: Date: |
|----------------------|------------------|
| Applicant Signature: | Signature: Date: |

Crown or General Manager Land Owner Consent

If the land that is the subject of this application is owned or administered by either the Crown or Sorell Council, the consent of the relevant Minister or the Council General Manager whichever is applicable, must be included here. This consent should be completed and signed by either the General Manager, the Minister, or a delegate (as specified in s52 (1D-1G) of the *Land Use Planning and Approvals Act 1993*).

Please note:

- If General Manager consent if required, please first complete the General Manager consent application form available on our website www.sorell.tas.gov.au
- If the application involves Crown land you will also need a letter of consent.
- Any consent is for the purposes of making this application only and is not consent to undertaken work or take any other action with respect to the proposed use or development.

| 1 | | being responsible for the |
|-----------------------------------|---|---|
| administration of land at | Sorell Council | |
| declare that I have given permiss | sion for the making of this application for | Development Application: Development Application - 445 Brinktop Road, Penna.pdf Plans Reference:P1 Date Received:18/06/2024 |
| Signature of General Manager, | Signatura | Data |



DA 2024.145.1 Response to Council RFI

Demolition of existing building and construction of a new building



Document Control Record

Document prepared by:

6ty° Pty Ltd

ABN 27 014 609 900

Postal Address

PO Box 63 Riverside Tasmania 7250

W 6ty.com.au

E admin@6ty.com.au

Launceston Office

Tamar Suite 103 The Charles 287 Charles Street Launceston 7250 P (03) 6332 3300



| Document Control 6ty° | | | | | | | | | |
|-----------------------|-----------|------------|--|-------------|-----------|--------|-----------|------------|--------------|
| Report Title: Respon | | | e to Cou | ıncil RFI [| DA 20 |)24 | .145.1 | | |
| Project Nu | ımber: | 19.332 | Project Name: Pontos Hills Machin | | nery Shed | | | | |
| Client: | | S. Smith | & Son Pty Ltd Client Contact: John Ide | | | | | | |
| Revision: | Date: | | Revisio | n details | :: | Pre | epared by | / : | Reviewed by: |
| 1 | 2 July 20 | 2024 Final | | | G. | Walker | | | |
| Current Revision: 1 | | 1 | | | | | | | |

Table of Contents

| 1. | Intro | duction | . 4 |
|----|-------|------------------------------|-----|
| | | Request Item 1 | |
| | | Response to Request Item 1 | |
| | | Request Item 2 | |
| | | Response to Request Item 2 | |
| | | Request Item 3 | |
| | | Response to Request Item 3 | |
| | 1.5.1 | 1.63ponse to 1.6quest item 5 | . 1 |

1. Introduction

6ty° Pty Ltd has been engaged by **S. Smith & Sons Pty Ltd** to prepare a response to a request for further information from **Sorell** in relation to a development application¹ for demolition of an existing office and machinery shed and construction of a new office and machinery shed on land located at 445 Brinktop Road, Penna (**'the site'**).

1.1 Request Item 1

The following information has been requested by Council:

"A current and full copy of title (including title plan) and details of any Restrictive Covenants or other restrictions on the title. This title must have been searched within the last six (6) months."

1.1.1 Response to Request Item 1

A new copy of the certificate of title for the site including the folio plan and text and schedule of easement has been obtained and is provided in **Appendix A**.

1.2 Request Item 2

The following information has been requested by Council:

"A written statement and associated amended plans that address and respond to the 'Acceptable Solution(s)' or 'Performance Criteria' of the Electrical Transmission Code – C4.5 Use Standards and C4.6 Development Standards for Buildings and works of the TPS."

1.2.1 Response to Request Item 2

1.2.1.1 Assessment against clause C4.5

| C4.5 | C4.5 Use Standards | | | | |
|------|--|---|----------------|--|--|
| Stan | dard | Assessment | Compliance | | |
| C4.5 | 1 Sensitive use within a substation | n facility buffer area | | | |
| A1 | A sensitive use, excluding any non- habitable rooms, contained within a building and located within a substation facility buffer area must: | used for a sensitive use ² and the site is not subject to a substation | | | |
| | (a) be for an existing sensitive use, provided the distance between the building and the substation facility is not reduced; or | | Not Applicable | | |
| | (b) not be exposed to substation noise emission higher than: | | Not Applicable | | |

¹ means an application for a permit made under this planning scheme. Table 3.1, Scheme.

"means a residential use or a use involving the presence of people for extended periods except in the course of their employment such as a caravan park, childcare centre, dwelling, hospital or school". Table 3.1, Scheme.

² Sensitive Use

| C4.5 Use Standards | | | | |
|--------------------|--|--|-----------------|--|
| Stand | lard | Assessment | Compliance | |
| | (i) 55 dB(A) (LAeq) within the hours of 8:00am to 6:00pm; | | Not Applicable | |
| | (ii) dB(A) above the background (LA90) level or 40 dB(A) (LAeq), whichever is the lower, within the hours of 6:00pm to 8:00am; and | | Not Applicable | |
| | (iii) 65 dB(A) (LAmax). | | Not Applicable | |
| | Noise levels are to be averaged over a 15 minute interval. | | Not Applicable | |
| C4.5. | 2 Dust or other airborne particular | tes within an electricity transmiss | ion corridor | |
| A1 | No Acceptable Solution | There is no Acceptable Solution. Notwithstanding this, the proposed building is categorised into the Resource Development Use Class in accordance with clause 6.2.1 and Table 6.2 of the Scheme which is not a Use Class listed in Table C4.1. Accordingly, the corresponding Performance Criteria is not an applicable standard pursuant to clause 5.6.2(c) of the Scheme. | .Not Applicable | |
| C4.5. | 3 Dust or other airborne particular | tes within a substation facility but | ffer area | |
| A1 | No Acceptable Solution | There is no Acceptable Solution. Notwithstanding this, the proposed building is categorised into the Resource Development Use Class in accordance with clause 6.2.1 and Table 6.2 of the Scheme which is not a Use Class listed in Table C4.1. Accordingly, the corresponding Performance Criteria is not an applicable standard pursuant to clause 5.6.2(c) of the Scheme. Furthermore, the site is not subject to a substation facility buffer area. | Not Applicable | |

1.2.1.2 Assessment against clause C4.6

| C4.6 Development Standards for Buildings or Works | | |
|---|--|--|
| Standard Assessment Compliance | | |
| C4.6.1 Buildings or works within an electricity transmission corridor | | |

| C4.6 | Development Standards for Buildi | ngs or Works | |
|-------|--|---|----------------|
| Stand | dard | Assessment | Compliance |
| A1 | Buildings or works within an electricity transmission corridor must not be within: | | |
| | (a) an inner protection area; or | The submitted Local Site Plan (Project No. 19.332 Drawing No. Ap03 Rev. 003 dated 17-06-24) illustrates all buildings and works being located outside the inner protection area of the electricity transmission corridor. | |
| | (b) a registered electricity easement. | The application satisfies subclause A1(a) for compliance with the Standard. | Not Applicable |
| C4.6. | 2 Buildings or works within a sub | station facility buffer area | |
| A1 | Buildings or works within a substation facility buffer area must be located not less than 5m from a substation facility. | The site is not subject to a substation facility buffer area. | Not Applicable |
| C4.6. | 3 Buildings or works within a com | munications station buffer area | |
| A1 | Buildings or works within a communications station buffer area must: | The site is not subject to a communications station buffer area. | |
| | (a) be located: | | Not Applicable |
| | (i) not less than 5m from any security fence associated with a communications station; or | | Not Applicable |
| | (ii) not less than 5m from a lot boundary of a lot containing a communications station; and | | Not Applicable |
| | (b) building height must be not more than the height of the communications station's antennae. | | Not Applicable |

1.3 Request Item 3

The following information has been requested by Council:

"A written statement and associated amended plans that address and respond to the 'Acceptable Solution(s)' or 'Performance Criteria' of the Scenic Protection Code – C8.6 Development Standards for Buildings and Works of the TPS."

1.3.1 Response to Request Item 3

1.3.1.1 Assessment against clause C8.6

| C8.6 D | evelopment Standards for Buildin | gs and Works | |
|--------|--|---|--------------------------------------|
| Standa | ard | Assessment | Compliance |
| C8.6.1 | Development within a scenic pr | otection area | |
| A1 | Buildings or works, including destruction of vegetation, within a scenic protection area must: | The application involves the demolition of an existing building, construction of a new building and removal of a tree and understory shrubs within the Pontos Hills (Eastern Hillside) Scenic Management Area. | |
| | (a) be on land not less than 50m in elevation below a skyline; and | The maximum elevation of the Pontos Hills range directly southwest of the proposed building is approximately 195m Australia Height Datum (AHD). The elevation is the highest point of the skyline of the Pontos Hills range which forms the backdrop of the site and proposed building. | |
| | | The proposed building will be located on land that will have a finished elevation of approximately 109.5m AHD (which is approximately equivalent to the finished floor level of the proposed building). | |
| | | The proposed building and works will therefore be on land that is located on land that is 85.5m in elevation below the top of the Pontos Hills skyline. | |
| | (b) not total more than 500m² in extent. | The proposed building will have a gross floor area of 670m ² . | Relies on Performance Criteria |
| C8.6.2 | Development within a scenic ro | ad corridor | |
| A1 | Destruction of exotic trees with a height more than 10m, native vegetation, or hedgerows within a scenic road corridor must not be visible from the scenic road. | | Not Applicable |
| A2 | Buildings or works within a scenic road corridor must not be visible from the scenic road. | | Not Applicable |

1.3.1.2 Assessment against Performance Criteria C8.6.1 P1.1 and P1.2

| C8.6.1 | Development within a scenic protection area |
|----------|---|
| Objectiv | ve |

That:

- (a) destruction of vegetation does not cause an unreasonable reduction of the scenic value of a scenic protection area; and
- (b) buildings and works do not cause an unreasonable reduction of the scenic value of a scenic protection area.

Performance Criteria P1.1

Assessment

Destruction of vegetation within a scenic The removal of the tree and associated area, having regard to:

protection area must not cause an unreasonable understorey within the Pontos Hills scenic impact on the scenic value of a scenic protection management area will not cause an unreasonable impact on the scenic value of the scenic protection area.

> The term "unreasonable" was found by the former Resource Management and Planning Appeal tribunal to be something that is "immoderate" or "exorbitant".3

> Clause SOR-Table C8.1 of the Scheme defines the scenic value for the Pontos Hills (eastern hillside) scenic management area as:

> "Provides a key skyline generally running parallel with the Tasman Highway and frames Orielton valley when viewed from public roads as well as in the Sorell Township".

> The following assessment is approached within this context.

(a) the nature of the vegetation to be removed;

The vegetation to be removed consists of a medium sized Eucalyptus viminalis tree which is located at the north-eastern end of the existing building. The single tree forms part of a series of eucalyptus tree copses that extend along the eastern side of Pontos Hills in a north-south alignment. Whilst contributing to the tapestry of vegetation along the eastern side of Pontos Hill, its removal will not be evident within context of treed landscape along the eastern side of Pontos Hills.

(b) the area of vegetation to be removed;

The vegetation to be removed is located at the north-eastern corner of the existing building. The vegetation is required to be removed to accommodate the proposed new building the footprint of which will extend further north-west of the footprint of the existing building.

(c) the topography of the site;

The topography of the site at the building area is relatively level. The building area will extend in a general north to south alignment which will follow the contours.

(d) any visual impact on a skyline;

The vegetation to be removed is located approximately 85m below the top of the skyline

³ J Dunn v Central Coast Council and PLA Design [2018] TASRMPAT 27 at [49].A & N McCullagh v Glamorgan Spring Bay Council [2019] TASRMPAT 30 at [24].

| | | formed by the Pontos Hills range. The canopy of the tree to be removed is therefore located significantly below, and does not form part of, the skyline. |
|------------|--|---|
| (e) | the nature of the reduction of the scenic value; and | The removal of the vegetation will not result in a material reduction of the scenic value of the scenic protection area which is the skyline formed the by Pontos Hills range. In this regard, the proposed vegetation removal is minimal in scale and extent relative to the tapestry of vegetation along the eastern hillside of Pontos Hills and is significantly below, and does not form part of, the skyline established by Pontos Hills. |
| (f) | the purpose of any management objectives identified in the relevant Local Provisions Schedule. | Consideration of the management objectives identified for the Pontos Hills (eastern hillside) management objectives listed in Table SOR-Table C8.1 of the Sorell Local Provisions Schedule is provided in section 1.3.1.3 below. |
| Conclusion | | Removal of the vegetation will not have an immoderate or exorbitant impact on the defined scenic values of the Pontos Hills scenic management area which is the skyline formed by the Pontos Hills range. In this regard, removal of the vegetation is not unreasonable. |
| Perfor | rmance Criteria P1.2 | Assessment |
| | | The demolition of the existing building and construction of the new building within the Pontos |

regard to:

scenic value of a scenic protection area, having Hills scenic management area will not cause an unreasonable impact on the scenic value of the scenic protection area.

> The term "unreasonable" was found by the former Resource Management and Planning Appeal tribunal to be something that is "immoderate" or "exorbitant".4

> Clause SOR-Table C8.1 of the Scheme defines the scenic value for the Pontos Hills (eastern hillside) scenic management area as:

> "Provides a key skyline generally running parallel with the Tasman Highway and frames Orielton valley when viewed from public roads as well as in the Sorell Township".

> The following assessment is approached within this context.

(a) the topography of the site;

The topography of the site at the building area is relatively level. The building area will extend in a general north to south alignment which will follow the contours.

⁴ J Dunn v Central Coast Council and PLA Design [2018] TASRMPAT 27 at [49].A & N McCullagh v Glamorgan Spring Bay Council [2019] TASRMPAT 30 at [24].

- (b) the location of, and materials used in construction of, driveways or access tracks:
- (c) proposed reflectance and colour of external finishes:

(d) design and proposed location of the buildings or works;

The application does not involve the construction of driveways or access tracks. In this regard, the existing driveway between Brinktop Road and the existing building and proposed building will be retained.

The external cladding of the majority of the proposed building will be sheet metal with a monument colour (or similar) which has a light reflectance value (LRV) of around 10%. The north-eastern corner of the shed around the office and amenities area of the proposed building will include glazed windows and vertical timber cladding which will be task oak or spotted gum (or similar) which will have a natural and muted finish. The external finishes of the proposed building have been designed to match or complement the external finishes of the existing winery building. They will have a low LRV making the building recessive within the landscape.

Visualisations have been prepared for the proposed building which are included in **Appendix B**.

The proposed building will be rectangular in shape with a width of approximately 12.5m and length of approximately 53.5m. The rectangular shape and orientation of the proposed building will match the shape and orientation of the existing building which is orientated in a general north to south alignment. The footprint of the proposed building will encompass the footprint of the existing building where the proposed building extending marginally to the south-east beyond the footprint of the existing building and extending mor significantly to the north-west beyond the footprint of the existing building. The proposed building will have a skillion roof profile with a high point of 6.1m at the eastern end.

The proposed building will be upslope and to the north-west of recently completed winery building which has a significantly larger area, height and scale than the proposed building. In this regard, the existing winery building has a footprint (building only) of 4,526m² and a maximum height of 18.4m measured to the top of the lift shaft of the viewing platform located at the north-eastern corner of the winery building.

For perspective:

- the Relative Level (RL) of the existing winery building is 113.48m ADH and the RL of the proposed building is 115.66m AHD;
- the absolute height of the proposed building is ~30% less than the existing winery building;

| | the gross floor area of the proposed building will be ~85% less than the existing winery building. |
|--|---|
| (e) the extent of any cut or fill required; | Cut is required along the western and southwestern ends of the proposed building to facilitate a level building area including the concrete apron around the western and southern sides of the building. The cut will have a maximum depth of 2.89m the extent of which is shown on the submitted elevation plan (Project No. 19.332 Drawing No. 1Ap02 Rev 002 dated 17-06-24). |
| | The proposed cut will lower the overall relative height of the building on the site. |
| (f) any visual impact on a skyline; | The proposed building will be located on land that is approximately 85m below the highest point of the adjacent skyline formed by Pontos Hills. The location and design of the proposed building will therefore have no impact on the skyline. |
| (g) any existing or proposed screening; and | The proposed building will not be provided with explicit screening. It is proposed to provide some landscaping around the building toward the office end (northern end) of the building. General screening and visual buffers of the proposed building FROM Brinktop Road will be provided by the physical distance between the proposed building and Brinktop Road (approximately 820m), established vineyard and vegetation between the proposed building and Brinktop Road and the low contrasting external finishes of the proposed building. |
| (h) the purpose of any management objectives identified in the relevant Local Provisions Schedule. | Consideration of the management objectives identified for the Pontos Hills (eastern hillside) management objectives listed in Table SOR-Table C8.1 of the Sorell Local Provisions Schedule is provided in section 1.3.1.3 below. |
| Conclusion | Demolition of the existing building and construction of the proposed new building will not have an immoderate or exorbitant impact on the defined scenic values of the Pontos Hills scenic management area which is the skyline formed by the Pontos Hills range. In this regard, the proposed building is not unreasonable. |

1.3.1.3 SOR-Table C8.1 – Scenic Protection Areas

| SOR-Table C8.1 Scenic Protection Areas – PONTOS HILLS (EASTERN HILLSIDE) | |
|--|---|
| Description | These hills run north/south and provide the western border to the Orielton Valley. The area is characterised by gently sloping pastoral land. |
| Scenic Value | Provides a key skyline generally running parallel with the Tasman Highway and frames Orielton valley when viewed from public roads as well as in the Sorell Township. |
| Management Objectives | Assessment |

SOR-Table C8.1 Scenic Protection Areas – PONTOS HILLS (EASTERN HILLSIDE) The proposed building is directly associated with an established (a) Maintain the agricultural agricultural use in the form of an extensive vineyard and winery of character operation. The proposed building will therefore directly align with the landscape. agricultural character of the landscape. The proposed tree removal and buildings will be located (b) Avoid significant approximately 85m below the highest point of the Pontos Hills skyline landscape change on hill and at the based of the eastern hillside. The proposed development faces and skylines. will therefore not result in a significant landscape change on the hill

face or skyline.

Postal Address PO Box 63 Riverside Tasmania 7250 W 6ty.com.au E admin@6ty.com.au

Tamar Suite 103 The Charles 287 Charles Street Launceston Tasmania P (03) 6332 3300

57 Best Street Devonport Tasmania P (03) 6424 7161 6ty Pty Ltd ABN 27 014 609 900

Designer Chester Bullock - CC1633i



VISUALISATION 1



VISUALISATION 2





VISUALISATION 3



VISUALISATION 4

Sorell Council

Development Application: Response to Request for Information - 445 Brinktop Road, Penna.pdf Plans Reference: P2 Date Received: 05/07/2024

DIMENSIONS ARE IN MILLIMETRES. DO NOT SCALE. CHECK AND VERIFY ALL DIMENSIONS ON SITE. REFER DISCREPANCIES TO THE SUPERINTENDENT. ALL WORK SHALL BE CARRIED OUT IN ACCORDANCE WITH: BUILDING CODE OF AUSTRALIA, APPLICABLE AUSTRALIAN STANDARDS AND LOCAL AUTHORITY REQUIREMENTS.

COPYRIGHT© THIS DRAWING AND ALL OF ITS CONTENT REMAIN THE PROPERTY OF 6ty Pty Ltd. THE DRAWINGS AND ITS CONTENT MAY NOT BE RETAINED, COPIED OR REPRODUCED IN PART OR WHOLLY, WITHOUT THE WRITTEN PERMISSION FROM 6ty Pty Ltd.

SOME SPECIFIED CONTENT, BRANDS AND MANUFACTURERS MAY BE COPYRIGHTED PROPERTY OF OTHERS, ACKNOWLEDGEMENT OF THESE COPYRIGHTS ARE HEREBY GIVE.

PROJECT: PROPOSED MACHINERY SHED &

OFFICE LOT 1 BRINKTOP ROAD, PENNA, TASMANIA

FOR: PONTOS HILLS WINERY

DRAWING: VISUALISATIONS

AT A1 SIZE DRAWING SHEET

PROJECT No. 19.332 DRAWING No. 1Ap03 REV. 003



6ty° Pty Ltd ABN 27 014 609 900

Postal Address

PO Box 63
Riverside
Tasmania 7250
W 6ty.com.au
E admin@6ty.com.au

Launceston Office

Tamar Suite 103 The Charles 287 Charles Street Launceston 7250 P (03) 6332 3300 Project: PROPOSED MACHINERY SHED & OFFICE

LOT 1 BRINKTOP ROAD, PENNA, TASMANIA

For: PONTOS HILLS WINERY

Project: 19.332

Drawings:

Ap01 OVERALL SITE PLAN
Ap02 SITE DEMOLITION PLAN
Ap03 SITE PLAN
1Ap01 FLOOR & ROOF PLAN
1Ap02 ELEVATIONS



Postal Address PO Box 63 Riverside Tasmania 7250 W 6ty.com.au E admin@6ty.com.a

ABN 27 014 609 900

Designer
Chester Bullock - CC1633

Tamar Suite 103
The Charles
287 Charles Street
Launceston Tasmania
P. (03) 6332 3300

57 Best Street Devonport Tasmania P (03) 6424 7161




PLANNING DOCUMENT

Issue date: 17-06-2024





LOCATION PLAN

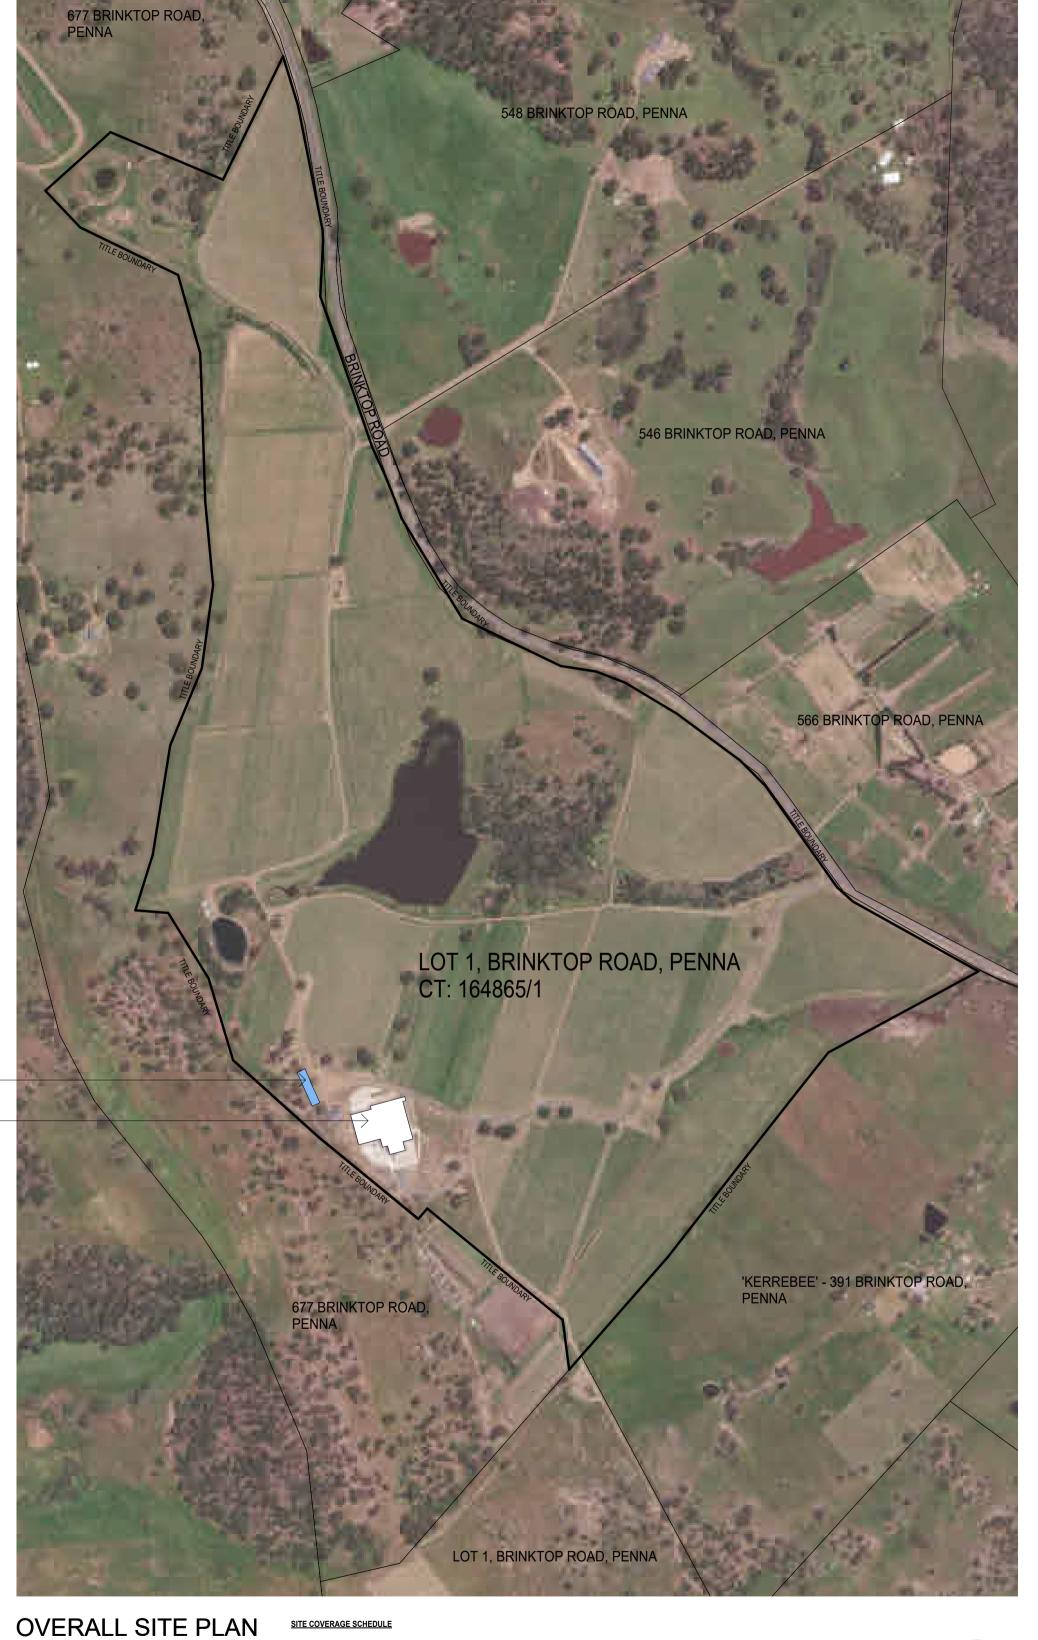

SITE COVERAGE SCHEDULE

RETAINED EXISTING BUILDING AREA DEMOLISHED EXISTING BUILDING AREA

TOTAL SITE AREA

PROPOSED BUILDING

TOTAL SITE COVERAGE

PROPOSED WORKS -

EXISTING BUILDING -

SCALE 1:5000

Postal Address PO Box 63 Riverside Tasmania 7250

W 6ty.com.au E admin@6ty.com.au

Tamar Suite 103

The Charles
287 Charles Street
Launceston Tasmania
P (03) 6332 3300

57 Best Street Devonport Tasmania P (03) 6424 7161

17.10.23 CLIENT INFORMATION
10-05-24 ISSUED FOR PLANNING APPROVAL
17-06-24 ISSUED FOR PLANNING APPROVAL

6ty Pty Ltd ABN 27 014 609 900

Designer Chester Bullock - CC1633i


DIMENSIONS ARE IN MILLIMETRES. DO NOT SCALE. CHECK AND VERIFY ALL DIMENSIONS ON SITE. REFER DISCREPANCIES TO THE SUPERINTENDENT. ALL WORK SHALL BE CARRIED OUT IN ACCORDANCE WITH: BUILDING CODE OF AUSTRALIA, APPLICABLE AUSTRALIAN STANDARDS AND LOCAL AUTHORITY REQUIREMENTS.

COPYRIGHT® THIS DRAWING AND ALL OF ITS CONTENT REMAIN THE PROPERTY OF 6ty Pty Ltd. THE DRAWINGS AND ITS CONTENT MAY NOT BE RETAINED, COPIED OR REPRODUCED IN PART OR WHOLLY, WITHOUT THE WRITTEN PERMISSION FROM 6ty Pty Ltd.

SOME SPECIFIED CONTENT, BRANDS AND MANUFACTURERS MAY BE COPYRIGHTED PROPERTY OF OTHERS, ACKNOWLEDGEMENT OF THESE COPYRIGHTS ARE HEREBY GIVE.

- PROPOSED MACHINERY SHED & OFFICE
- AT: LOT 1 BRINKTOP ROAD, PENNA, TASMANIA
- FOR: PONTOS HILLS WINERY

DRAWING: OVERALL SITE PLAN

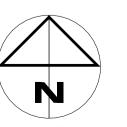

SCALES: As indicated AT A1

PROJECT No. 19.332 DRAWING No. Ap01

Sorell Council Development Application: Development Application - 445 Brinktop Road, Penna.pdf Plans Reference:P1 Date Received:18/06/2024



SITE DEMOLITION PLAN

SCALE 1:200



Postal Address PO Box 63 Riverside Tasmania 7250 W 6ty.com.au E admin@6ty.com.au 6ty Pty Ltd ABN 27 014 609 900 Designer Chester Bullock - CC1633i

Tamar Suite 103 The Charles
287 Charles Street
Launceston Tasmania
P (03) 6332 3300

57 Best Street Devonport Tasmania P (03) 6424 7161



17.10.23 CLIENT INFORMATION
10-05-24 ISSUED FOR PLANNING APPROVAL
17-06-24 ISSUED FOR PLANNING APPROVAL

Sorell Council

Development Application: Development Application - 445 Brinktop Road, Penna.pdf

Plans Reference:P1 Date Received:18/06/2024

DIMENSIONS ARE IN MILLIMETRES. DO NOT SCALE. CHECK AND VERIFY ALL DIMENSIONS ON SITE. REFER DISCREPANCIES TO THE SUPERINTENDENT. ALL WORK SHALL BE CARRIED OUT IN ACCORDANCE WITH: BUILDING CODE OF AUSTRALIA, APPLICABLE AUSTRALIAN STANDARDS AND LOCAL AUTHORITY REQUIREMENTS.
COPYRIGHT® THIS DRAWING AND ALL OF ITS CONTENT REMAIN THE PROPERTY OF 6ty Pty Ltd.
THE DRAWINGS AND ITS CONTENT MAY NOT BE RETAINED, COPIED OR REPRODUCED IN PART OR WHOLLY, WITHOUT THE WRITTEN PERMISSION FROM 6ty Pty Ltd.
SOME SPECIFIED CONTENT, BRANDS AND MANUFACTURERS MAY BE COPYRIGHTED PROPERTY OF OTHERS, ACKNOWLEDGEMENT OF THESE COPYRIGHTS ARE HEREBY GIVE.

PROPOSED MACHINERY SHED & OFFICE

LOT 1 BRINKTOP ROAD, PENNA, TASMANIA

FOR: PONTOS HILLS WINERY

DRAWING: SITE DEMOLITION PLAN



SCALES: 1:200

PROJECT No. 19.332 DRAWING No. Ap02



SITE COVERAGE SCHEDULE

TOTAL SITE AREA RETAINED EXISTING BUILDING AREA DEMOLISHED EXISTING BUILDING AREA PROPOSED BUILDING

TOTAL SITE COVERAGE

Postal Address PO Box 63 Riverside Tasmania 7250 W 6ty.com.au E admin@6ty.com.au 6ty Pty Ltd ABN 27 014 609 900 Designer Chester Bullock - CC1633i

Tamar Suite 103 The Charles 287 Charles Street Launceston Tasmania P (03) 6332 3300

57 Best Street Devonport Tasmania P (03) 6424 7161

17.10.23 CLIENT INFORMATION
10-05-24 ISSUED FOR PLANNING APPROVAL
17-06-24 ISSUED FOR PLANNING APPROVAL

Sorell Council

Development Application: Development Application - 445 Brinktop Road, Penna.pdf

Plans Reference:P1 Date Received:18/06/2024

DIMENSIONS ARE IN MILLIMETRES. DO NOT SCALE. CHECK AND VERIFY ALL DIMENSIONS ON SITE. REFER DISCREPANCIES TO THE SUPERINTENDENT. ALL WORK SHALL BE CARRIED OUT IN ACCORDANCE WITH: BUILDING CODE OF AUSTRALIA, APPLICABLE AUSTRALIAN STANDARDS AND LOCAL AUTHORITY REQUIREMENTS.
COPYRIGHT® THIS DRAWING AND ALL OF ITS CONTENT REMAIN THE PROPERTY OF 6ty Pty Ltd.
THE DRAWINGS AND ITS CONTENT MAY NOT BE RETAINED, COPIED OR REPRODUCED IN PART OR WHOLLY, WITHOUT THE WRITTEN PERMISSION FROM 6ty Pty Ltd.
SOME SPECIFIED CONTENT, BRANDS AND MANUFACTURERS MAY BE COPYRIGHTED PROPERTY OF OTHERS, ACKNOWLEDGEMENT OF THESE COPYRIGHTS ARE HEREBY GIVE.

PROPOSED MACHINERY SHED & OFFICE

LOT 1 BRINKTOP ROAD, PENNA, TASMANIA

FOR: PONTOS HILLS WINERY

DRAWING: SITE PLAN



SCALES: As indicated AT A1

PROJECT No. 19.332 DRAWING No. Ap03

LOCAL SITE PLAN

SCALE 1:200



Postal Address PO Box 63 Riverside Tasmania 7250 W 6ty.com.au E admin@6ty.com.au 6ty Pty Ltd ABN 27 014 609 900

Designer Chester Bullock - CC1633i

Tamar Suite 103
The Charles
287 Charles Street Launceston Tasmania P (03) 6332 3300

Devonport Tasmania P (03) 6424 7161

57 Best Street

QMS Certification Services

MACHINERY SHED **NETTING STORE** WORKSHOP STAFF ROOM

FLOOR PLAN

SCALE 1:100

10-05-24 ISSUED FOR PLANNING APPROVAL 17-06-24 ISSUED FOR PLANNING APPROVAL

LINE OF BUILDING BELOW DASHED TRIMDEK PROFILE ROOF SHEETING -FOLDED COLORBOND FLASHING ----COLORBOND GUTTER # FASCIA _ SYSTEM

Sorell Council

Plans Reference:P1 Date Received:18/06/2024

Development Application: Development Application - 445 Brinktop Road, Penna.pdf

DIMENSIONS ARE IN MILLIMETRES. DO NOT SCALE. CHECK AND VERIFY ALL DIMENSIONS ON SITE. REFER DISCREPANCIES TO THE SUPERINTENDENT. ALL WORK SHALL BE CARRIED OUT IN ACCORDANCE WITH: BUILDING CODE OF AUSTRALIA, APPLICABLE AUSTRALIAN STANDARDS AND LOCAL AUTHORITY REQUIREMENTS.


COPYRIGHT® THIS DRAWING AND ALL OF ITS CONTENT REMAIN THE PROPERTY OF 6ty Pty Ltd. THE DRAWINGS AND ITS CONTENT MAY NOT BE RETAINED, COPIED OR REPRODUCED IN PART OR WHOLLY, WITHOUT THE WRITTEN PERMISSION FROM 6ty Pty Ltd.

SOME SPECIFIED CONTENT, BRANDS AND MANUFACTURERS MAY BE COPYRIGHTED PROPERTY OF OTHERS, ACKNOWLEDGEMENT OF THESE COPYRIGHTS ARE HEREBY GIVE.

PROJECT: NEW MACHINERY SHED

- AT: LOT 1 BRINKTOP ROAD, PENNA, TASMANIA
- FOR: PONTOS HILLS WINERY

DRAWING: FLOOR & ROOF PLAN

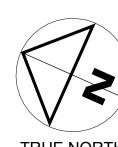


SCALES: 1:100

TRUE NORTH PROJECT No. 19.332 DRAWING No. 1Apo1 REV. 002

ROOF PLAN

SCALE 1:100

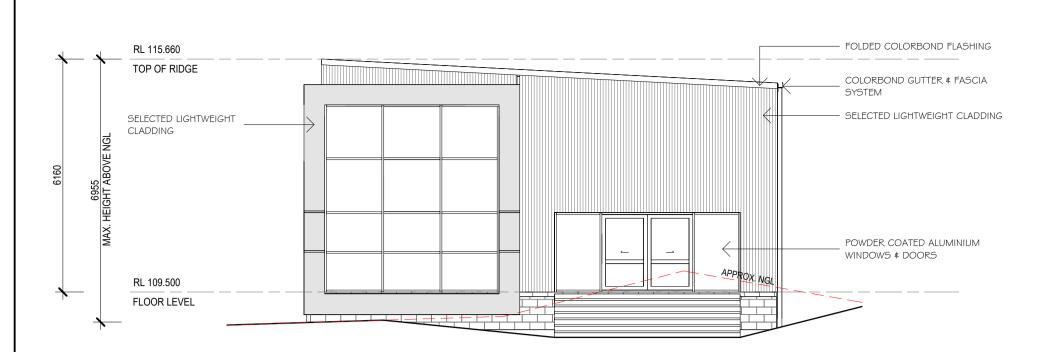

Postal Address PO Box 63 Riverside Tasmania 7250 W 6ty.com.au E admin@6ty.com.au 6ty Pty Ltd ABN 27 014 609 900 Designer Chester Bullock - CC1633i


Tamar Suite 103
The Charles
287 Charles Street Launceston Tasmania P (03) 6332 3300

57 Best Street Devonport Tasmania P (03) 6424 7161



NORTHERN ELEVATION


SCALE 1:100

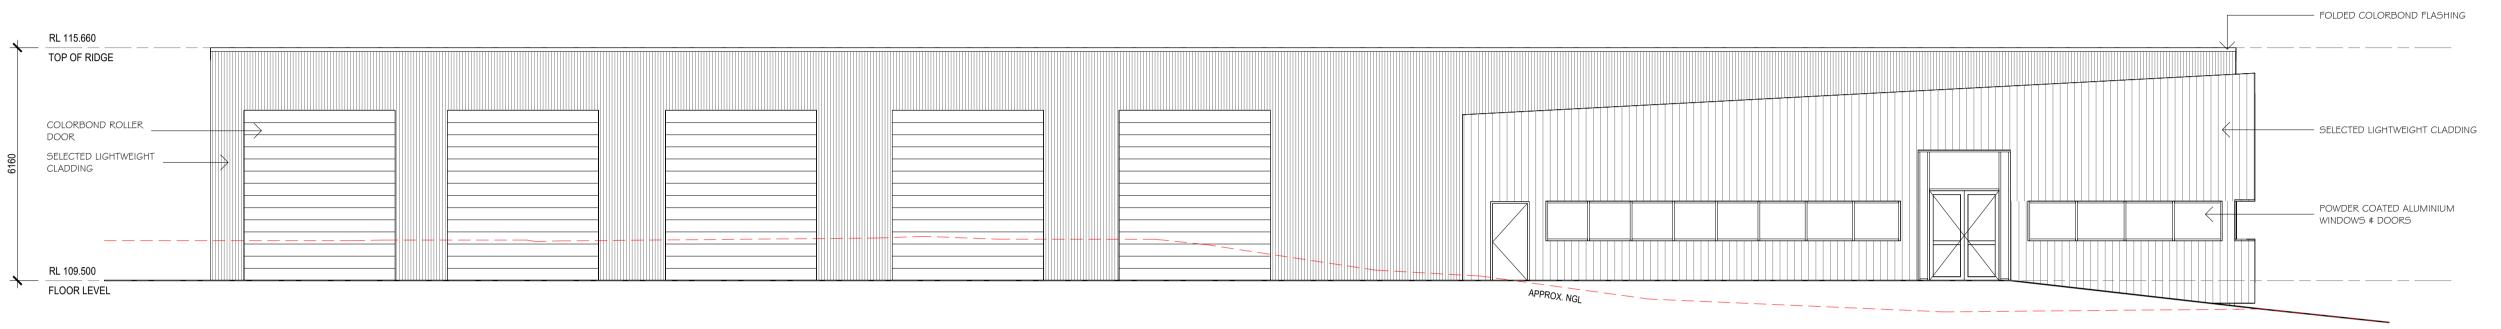

EASTERN ELEVATION


SCALE 1:100

10-05-24 ISSUED FOR PLANNING APPROVAL 17-06-24 ISSUED FOR PLANNING APPROVAL

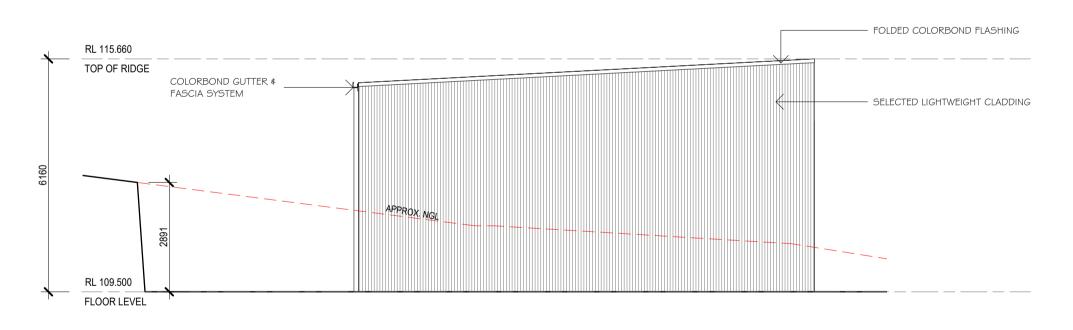

SOUTHERN ELEVATION

SCALE 1:100

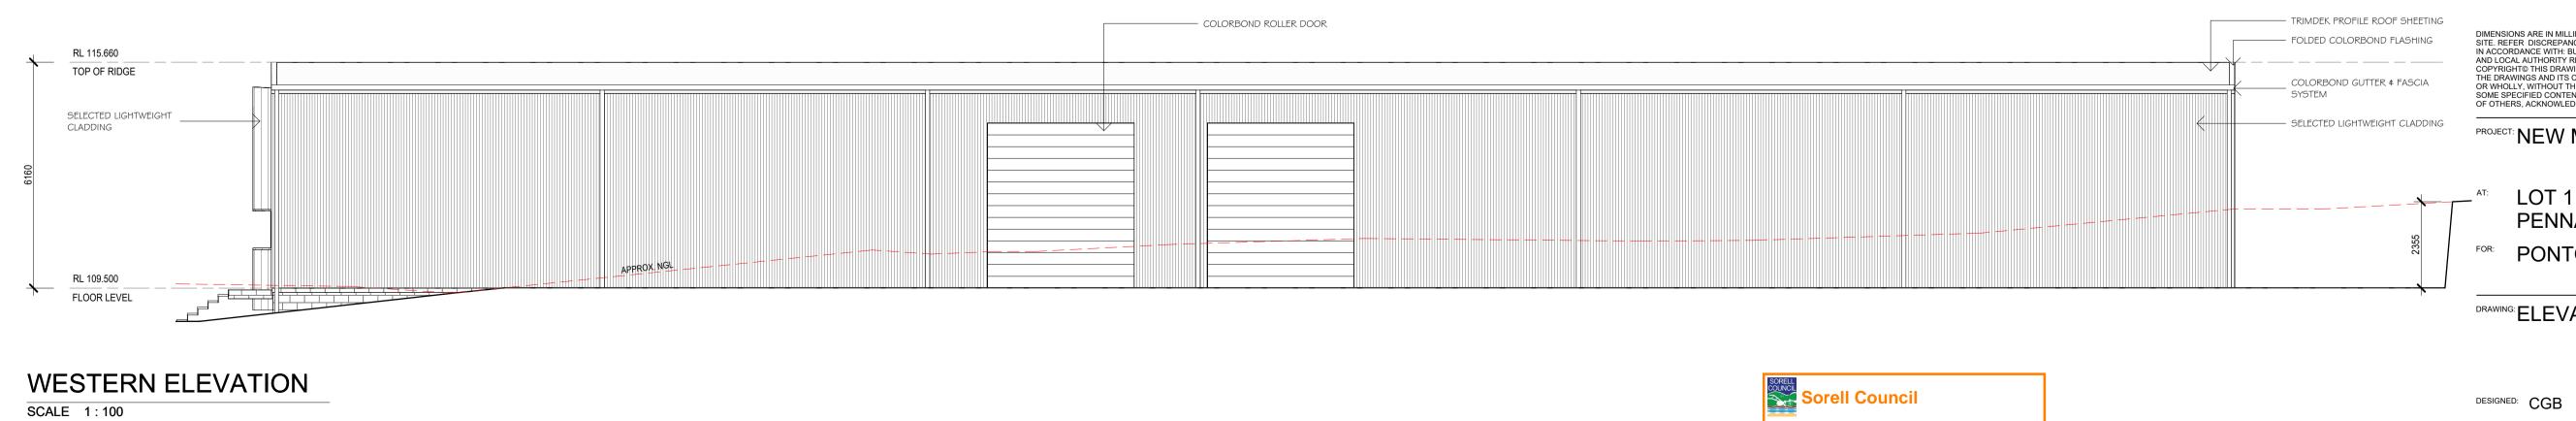

DIMENSIONS ARE IN MILLIMETRES. DO NOT SCALE. CHECK AND VERIFY ALL DIMENSIONS ON SITE. REFER DISCREPANCIES TO THE SUPERINTENDENT. ALL WORK SHALL BE CARRIED OUT IN ACCORDANCE WITH: BUILDING CODE OF AUSTRALIA, APPLICABLE AUSTRALIAN STANDARDS AND LOCAL AUTHORITY REQUIREMENTS.

COPYRIGHT® THIS DRAWING AND ALL OF ITS CONTENT REMAIN THE PROPERTY OF 6ty Pty Ltd. THE DRAWINGS AND ITS CONTENT MAY NOT BE RETAINED, COPIED OR REPRODUCED IN PART OR WHOLLY, WITHOUT THE WRITTEN PERMISSION FROM 6ty Pty Ltd.

SOME SPECIFIED CONTENT, BRANDS AND MANUFACTURERS MAY BE COPYRIGHTED PROPERTY OF OTHERS, ACKNOWLEDGEMENT OF THESE COPYRIGHTS ARE HEREBY GIVE.

PROJECT: NEW MACHINERY SHED

LOT 1 BRINKTOP ROAD, PENNA, TASMANIA

FOR: PONTOS HILLS WINERY

DRAWING: ELEVATIONS

SCALES: 1:100

PROJECT No. 19.332 DRAWING No. 1Ap02 REV. 002

Development Application: Development
Application - 445 Brinktop Road, Penna.pdf Plans Reference:P1

Date Received: 18/06/2024