

NOTICE OF PROPOSED DEVELOPMENT

Notice is hereby given that an application has been made for planning approval for the following development:

SITE: 4 Rantons Road, Dodges Ferry

PROPOSED DEVELOPMENT:

OUTBUILDING & FRONT FENCE


The relevant plans and documents can be inspected at the Council Offices at 47 Cole Street, Sorell during normal office hours, or the plans may be viewed on Council's website at www.sorell.tas.gov.au until **Monday 22**nd **July 2024.**

Any person may make representation in relation to the proposal by letter or electronic mail (<u>sorell.council@sorell.tas.gov.au</u>) addressed to the General Manager. Representations must be received no later than **Monday 22**nd **July 2024**.

APPLICANT: R A McLeod

APPLICATION NO: DA 2024 / 129 - 1

DATE: 04 July 2024

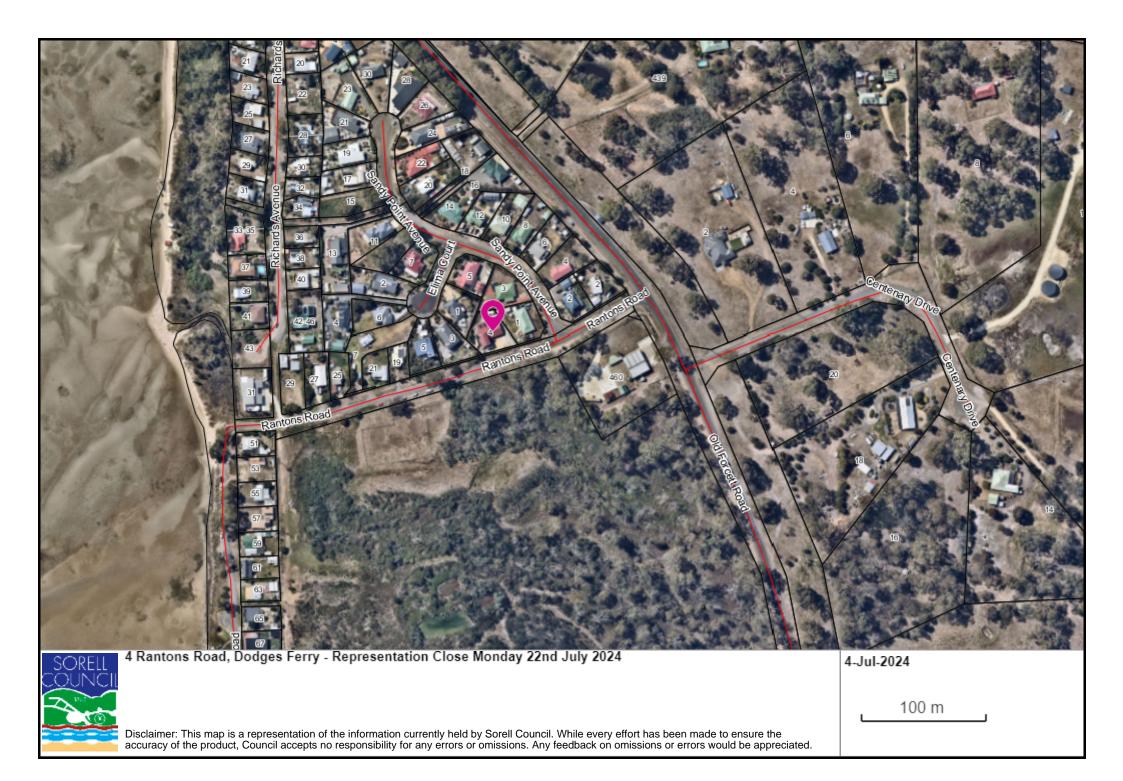

Part B: Please note that Part B of this form is publicly exhibited.

Full description of Proposal:	Use: Storage					
	Development: Outbuilding and front boundary fence replacement					
	Large or complex proposals should be described in a letter or planning report.					
Design and con	struction cost of proposal:	\$ 24,50	0			
Is all, or some th	ne work already constructed	: No: 🗹	Yes:			
Location of proposed works:	oroposed Suburb Dodges Ferry Postanda 7173					
Current Use of Site	Residential					
Current Owner/s:	Name(s)					
Is the Property on the Tasmanian Heritage Register?		No: ☑ Yes: □	If yes, please provide written advice from Heritage Tasmania			
Is the proposal to be carried out in more than one stage?		No: ☑ Yes: □	If yes, please clearly describe in plans			
Have any potentially contaminating uses been undertaken on the site?		No:☑ Yes: □	If yes, please complete the Additional Information for Non-Residential Use			
Is any vegetation proposed to be removed?		No: Yes:	If yes, please ensure plans clearly show area to be impacted			
Does the proposal involve land administered or owned by either the Crown or Council?			If yes, please complete the Council or Crown land section on page 3			
If a new or upgraded vehicular crossing is required from Council to the front boundary please						
complete the Vehicular Crossing (and Associated Works) application form https://www.sorell.tas.gov.au/services/engineering/						
TITEDS! AN AN AN'SOL	cii.tas.gov.au/sci vices/erigir	iceinig/	Sorell Council			

Development Application: Development Application - 4 Rantons Road, Dodges Ferry.pdf

Plans Reference:P1 Date Received:5/06/2024

Part B continued: Please note that Part B of this form is publicly exhibited

Declarations and acknowledgements

- I/we confirm that the application does not contradict any easement, covenant or restriction specified in the Certificate of Title, Schedule of Easements or Part 5 Agreement for the land.
- I/we consent to Council employees or consultants entering the site and have arranged permission and/or access for Council's representatives to enter the land at any time during normal business hours.
- I/we authorise the provision of a copy of any documents relating to this application to any person for the purposes of assessment or public consultation and have permission of the copyright owner for such copies.
- I/we declare that, in accordance with s52(1) of the Land Use Planning and Approvals Act 1993, that I have notified the owner(s) of the intention to make this application.
- I/we declare that the information in this application is true and correct.

Details of how the Council manages personal information and how you can request access or corrections to it is outlined in Council's Privacy Policy available on the Council website.

- I/we acknowledge that the documentation submitted in support of my application will become a public record held by Council and may be reproduced by Council in both electronic and hard copy format in order to facilitate the assessment process, for display purposes during public exhibition, and to fulfil its statutory obligations. I further acknowledge that following determination of my application, Council will store documentation relating to my application in electronic format only.
- Where the General Manager's consent is also required under s.14 of the Urban Drainage Act 2013, by making this application I/we also apply for that consent.

Applicant Signature:	R McLeod 25-05	5-24
Applicant Signature.	Signature:R McLeod (May 25; 2024 19:04 GM7+10) Date:	

Crown or General Manager Land Owner Consent

If the land that is the subject of this application is owned or administered by either the Crown or Sorell Council, the consent of the relevant Minister or the Council General Manager whichever is applicable, must be included here. This consent should be completed and signed by either the General Manager, the Minister, or a delegate (as specified in s52 (1D-1G) of the Land Use Planning and Approvals Act 1993).

Please note:

- If General Manager consent if required, please first complete the General Manager consent application form available on our website www.sorell.tas.gov.au
- If the application involves Crown land you will also need a letter of consent.
- Any consent is for the purposes of making this application only and is not consent to undertaken work or take any other action with respect to the proposed use or development.

Iadministration of land at		being responsible for the	
declare that I have given permis	Development Application: Development Application - 4 Rantons Road, Dodges Ferry Plans Reference:P1 Date Received:5/06/2024	rry.pdf	
Signature of General Manager, Minister or Delegate:	Signature:	Date:	

To Whom it may concern,

Please see attached my application to erect an outbuilding and replace the existing timber paling front boundary fence on my property at 4 Rantons Road Dodges Ferry.

Due to the position of the existing dwelling, as well as the location of the absorption trenches, the proposed location is the only suitable space available on the site.

As the proposed outbuilding does not meet **10.4.3** Acceptable solution **A1** or **A2**, below I have addressed **Performance criteria P1 & P2**.

10.4.3 P1 Performance criteria

- **b)** There are multiple properties around the surrounding area with outbuildings having similar setbacks which highlights that the outbuilding is compatible with the character of development existing on the established properties in the area. For example, No.2 Rantons Rd has an outbuilding of similar height and setback, as does No.8 Richards Ave which is in the neighbouring street. 45 Rantons Rd also has a similar height and style boundary fence.
- c) The new outbuilding will be lower in height, shorter in length and of considerably less bulk than the existing residence already on the property.
- **d)** As Rantons Rd is a sloping street, the ground level of the site is elevated from the road by nearly 2m. When viewed from the road and public open spaces adjacent to the site, there will be a very minimal amount of the new outbuilding visible as it will be concealed behind the new front boundary fence. The streetscape will also be greatly improved with the new, clean and sleek looking horizontal aluminium slat front fence, which will be coloured Colourbond Classic cream to match the new outbuilding and the upper story of the existing residence.

I have attached a picture of the current streetscape and a concept picture of the proposed streetscape to this application.

10.4.3 P2 Performance criteria

- **b)** The new outbuilding and front fence will not cause any loss of amenity to the adjoining properties due to the size, shape, or orientation of the site.
- c) There will be no Loss of Amenity to any of the adjoining properties caused by the setbacks of the surrounding buildings.
- **d)** The neighbouring properties were taken into consideration when designing the outbuilding and boundary fence, by keeping roof height as low profile as possible and the front fence having min 30% transparent as to not cause any loss of amenity and to allow for passive surveillance.
- **e)** The existing residence will cause no loss of amenity to the neighbouring properties as it will remain unchanged in its same position.
- **f)** The position of neither the outbuilding or front boundary fence will not create any shading or loss of sunlight to any private open space or windows of habitable rooms of adjoining properties.
- g) The front boundary fence and outbuilding will not cause any unreasonable loss of amenity to the character of any of the existing properties in the area and will allow for security and privacy.

Please don't hesitate to contact me if you require any further information.

Regards,

Robert McLeod



Development Application: Development
Application - 4 Rantons Road, Dodges Ferry.pdf

Plans Reference:P1 Date Received:5/06/2024



20th February 2024

ON-SITE WASTEWATER ASSESSMENT FOR 4 Rantons Road Lewisham

An Application has been submitted to the Sorell Council by the property owners of the above property to construct a shed

Council has requested that a suitably qualified person assess the current onsite wastewater system and provide a report showing that there is adequate area onsite to replace the existing OSWMS when an upgrade is required.

Description

The Dwelling of 4 bedrooms is situated on a block of approximately 917 M²

The existing wastewater management system consists of a min 2500L Concrete Septic Tank for WC & Kitchen wastewater only that discharges to a 10M absorption trench

All greywater is disposed to a separate absorption trench of approx. 12M

The Land Application Area for primary treated effluent from the septic tank and greywater fixtures are positioned in the southwestern area of the property and towards the side and rear of the dwelling as indicated on the attached site information.

The absorption trenches seem to be working satisfactorily with no visible signs of failure.

The House was constructed approx. 30rys ago in 1994 and some renovations were carried out in 2009.

The soils in the area are predominantly deep Sands of dark silty fine and loose structure ref Land Systems of Tas. (Dept of Ag)

A Hand Auger was used to investigate the soil profile with dark silty sands of 2.0m in depth

Wastewater System Assessment

The septic tank was located, at the rear of the dwelling capacity of 2500Lts.

The septic tank treated wastewater from the wc's and kitchen sink.

The length and dimensions of the absorption trench indicated on Councils plan show $10M \times 0.6M \times 0.6M$

All Greywater fixtures discharge to a separate absorption trench of 12Mx 0.6M x 0.6M.

There is adequate area at the rear of the dwelling for a suitable replacement wastewater system when necessary.

However due to the current Domestic Wastewater Standards and Guidelines for Onsite wastewater Management Systems there may not be enough area available considering the required boundary & house setbacks onsite for a replacement absorption trench system.

Conclusions & Recommendations


- Due to the information gained onsite regarding the existing Wastewater
 System it is recommended that the current Septic Tank and absorption
 trenches remain in operation until it is required to be replaced.
- The Septic Tank to be pumped out on a 4-5yrly basis and its recommended to install a filter in outlet junction to improve effluent discharge quality and prolong the life of the absorption trench.
- The hydraulic load on the wastewater system is currently 4 bedrooms with a max loading of 720ltrs/day i.e. for a maximum occupancy of 5 persons
- When its necessary to replace the onsite wastewater management system a site assessment to be carried out in accordance with the Directors Guidelines for Onsite wastewater Management and to AS/NZS 1547:2012 to determine the best method of wastewater management for the property
- When necessary, a Plumbing Application to be submitted to Sorell Council with all the required information for the approval of future replacement of the Onsite Wastewater Management System.


John Parkinson

Onsite Wastewater Solutions


www.oswws.com

<u>johnparkinson@oswws.com</u> 0409336306

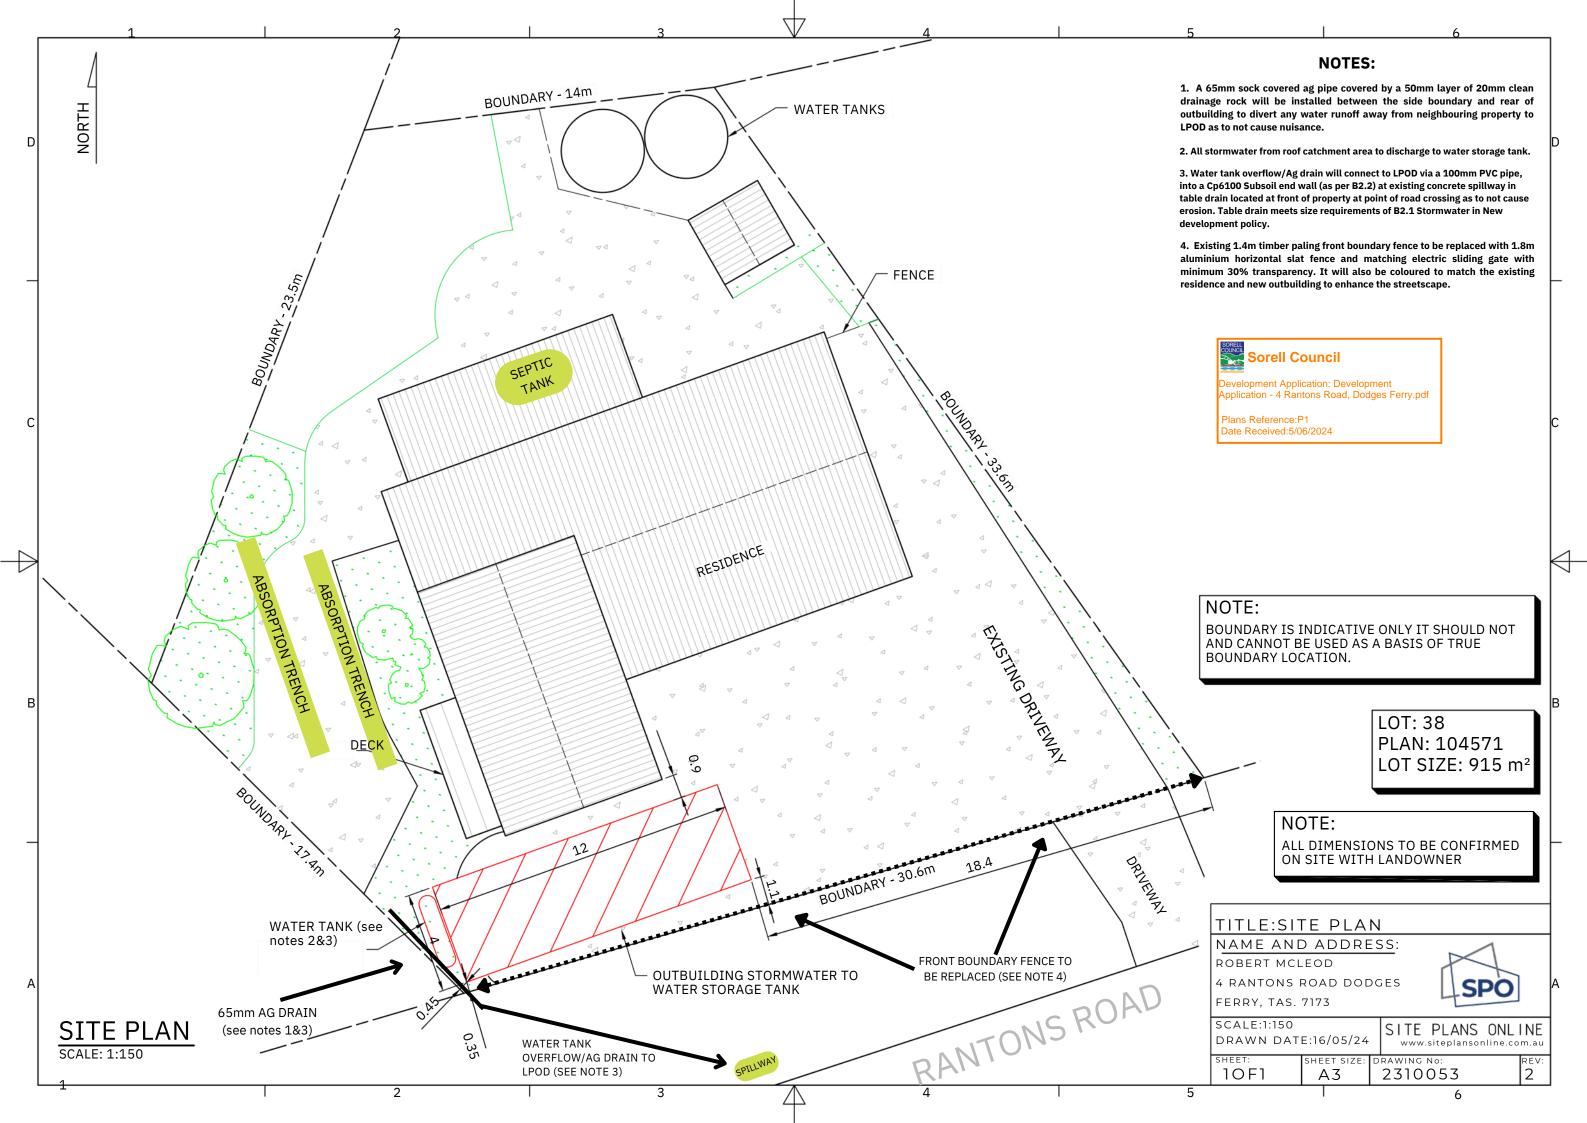

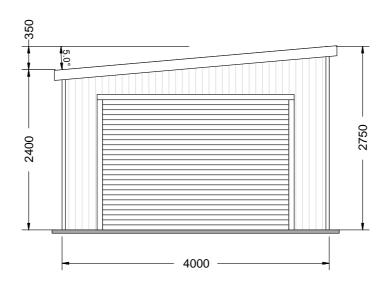

FRONT ELEVATION

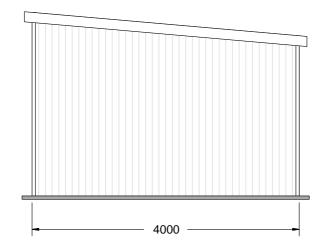



REAR ELEVATION



139 Main Road, Sorell TAS 7172 Phone: 1300 737 910

Email: sales@rainbowbuilding.com.au

CLIENT: Robert McLeod

DRAWING TITLE: End Elevations


SITE ADDRESS: 4 Rantons Road, DODGES FERRY, TAS, 7173 SCALE: 1:56.630

PHONE:

DATE: 04-09-2023 Job Number: SOR03_610

EMAIL: robbiemc_1983@hotmail.com

Drawing Number: EE

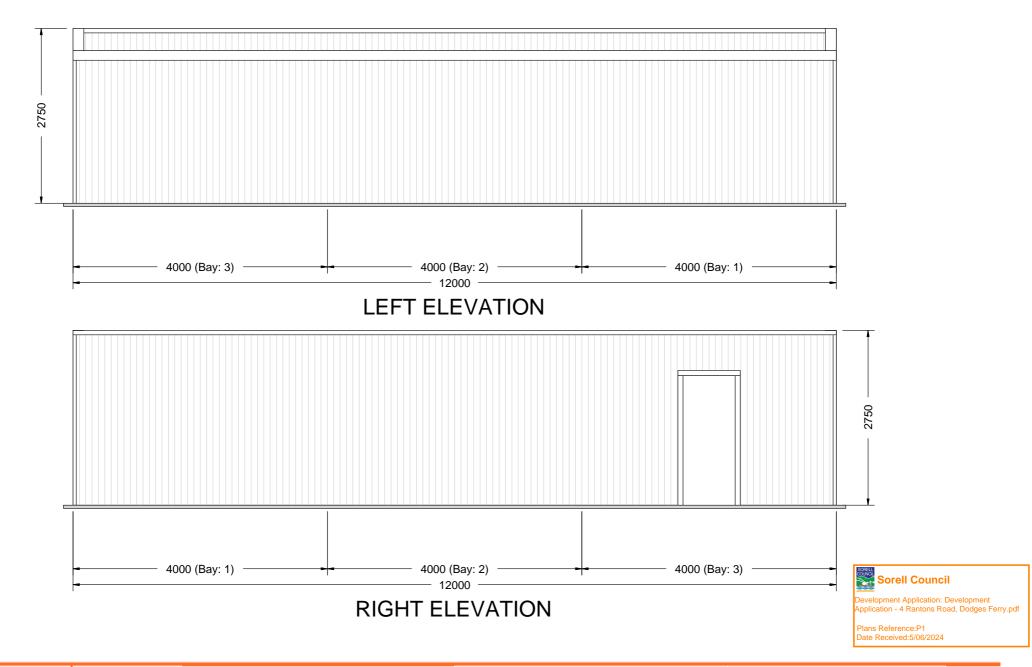



139 Main Road, Sorell TAS 7172 Phone: 1300 737 910

Email: sales@rainbowbuilding.com.au

CLIENT: Robert McLeod

DRAWING TITLE: Side Elevations


SITE ADDRESS: 4 Rantons Road, DODGES FERRY, TAS, 7173 SCALE: 1:59.466

PHONE: DATE: 04-09-2023

EMAIL: robbiemc_1983@hotmail.com

Job Number: SOR03_610

Drawing Number: SE

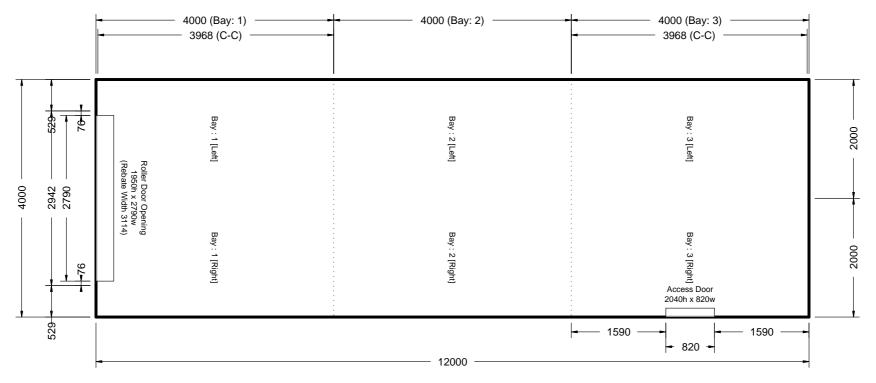

PLAN ELEVATION





139 Main Road, Sorell TAS 7172 Phone: 1300 737 910

Email: sales@rainbowbuilding.com.au

CLIENT: Robert McLeod


DRAWING TITLE: Plan Elevation

SITE ADDRESS: 4 Rantons Road, DODGES FERRY, TAS, 7173 SCALE: 1:63.654


PHONE: EMAIL: robbiemc_1983@hotmail.com

DATE: 04-09-2023 Job Number: SOR03_610

Drawing Number: FPE

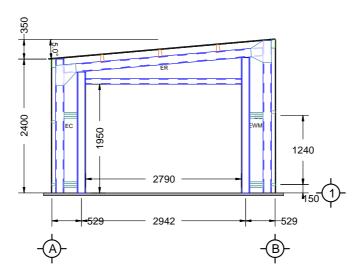

FRONT ELEVATION

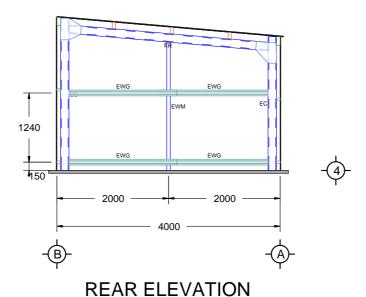





139 Main Road, Sorell TAS 7172 Phone: 1300 737 910

Email: sales@rainbowbuilding.com.au

CLIENT: Robert McLeod


DRAWING TITLE: End Frame Elevations

SITE ADDRESS: 4 Rantons Road, DODGES FERRY, TAS, 7173 SCALE: 1:67.797
PHONE: DATE: 04-09-202


PHONE: DATE: 04-09-2023

EMAIL: robbiemc_1983@hotmail.com Job Number: SOR03_610

Drawing Number: EFE

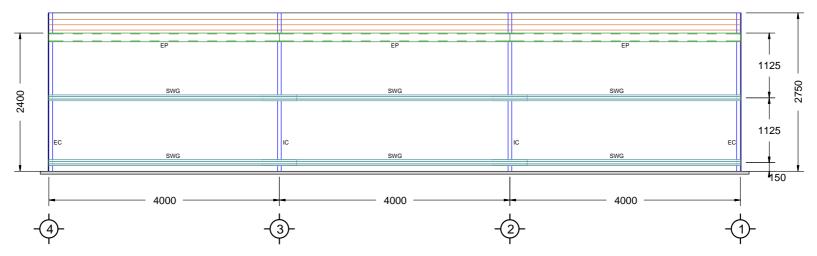

LEFT ELEVATION

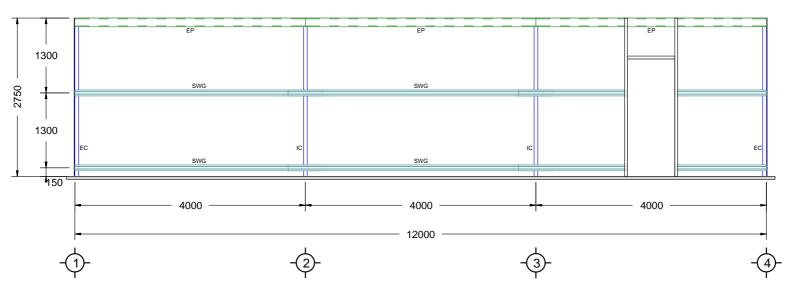



Development Application: Development Application - 4 Rantons Road, Dodges Ferry.pdf

Plans Reference:P1 Date Received:5/06/2024

RIGHT ELEVATION



Email: sales@rainbowbuilding.com.au

CLIENT: Robert McLeod DRAWING TITLE: Side Frame Elevations

SITE ADDRESS: 4 Rantons Road, DODGES FERRY, TAS, 7173 SCALE: 1:65.633


PHONE: DATE: 04-09-2023

EMAIL: robbiemc_1983@hotmail.com

Job Number: SOR03_610





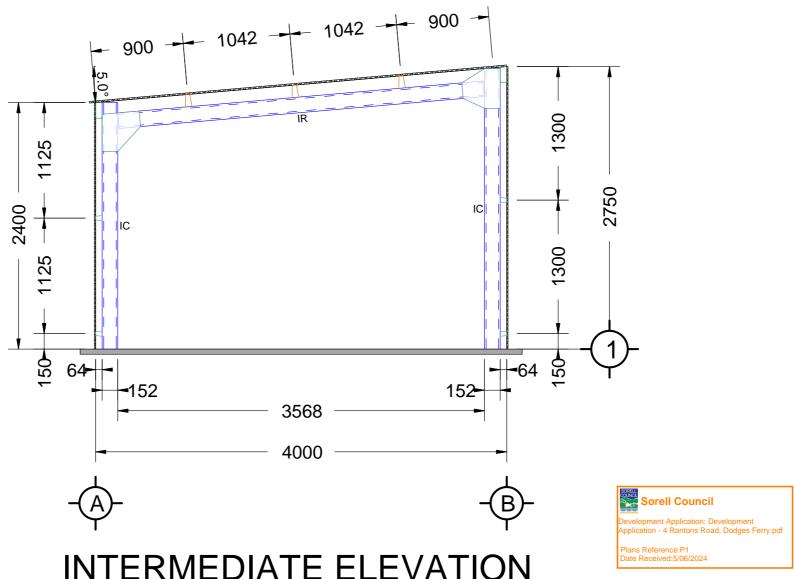

INTERMEDIATE ELEVATION



139 Main Road. Sorell TAS 7172 Phone: 1300 737 910

Email: sales@rainbowbuilding.com.au

CLIENT: Robert McLeod

PHONE:


DRAWING TITLE: Cross Section

SITE ADDRESS: 4 Rantons Road, DODGES FERRY, TAS, 7173 SCALE: 1:36.795

EMAIL: robbiemc_1983@hotmail.com

DATE: 04-09-2023 Job Number: SOR03_610

Drawing Number: CS

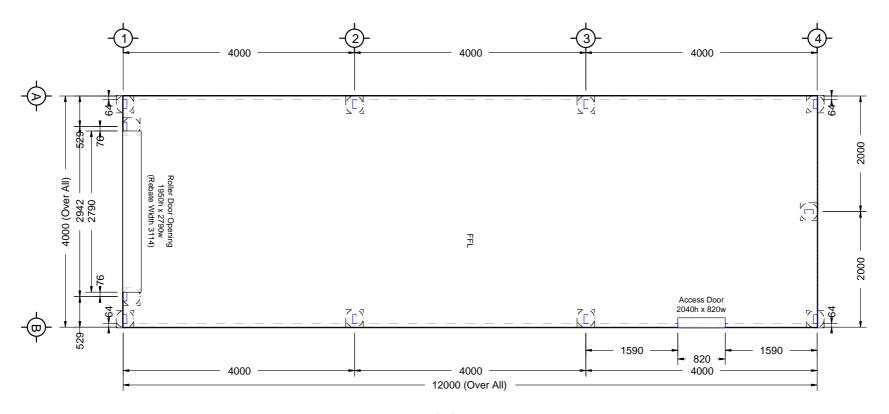

FLOOR PLAN





139 Main Road, Sorell TAS 7172 Phone: 1300 737 910 Email: sales@rainbowbuilding.com.au CLIENT: Robert McLeod

DRAWING TITLE: Floor Plan


SITE ADDRESS: 4 Rantons Road, DODGES FERRY, TAS, 7173 SCALE: 1:65.401

PHONE: DATE: 04-09-2023

EMAIL: robbiemc_1983@hotmail.com

Job Number: SOR03_610


Drawing Number: FP

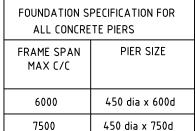


NOTE: STRIP SITE OF TOPSOIL VEGETATION MIN. 100 ROOT BALLS AND SOFT AREAS TO APPROVAL BEFORE PLACING


SL82 FABRIC TOP-

ANY FILL BELOW SLAB ALL CONCRETE EDGE BEAMS MUST BE FOUNDED ON FIRM NATURAL SUB-GRADE. DEEPEN EDGE BEAMS AS REQUIRED

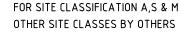


-SKILLION PIER FOUNDATION WHERE REQURIED (OPTIONAL) NOTE: REFER SITE SPECIFICATION & ELEVATION DRAWINGS

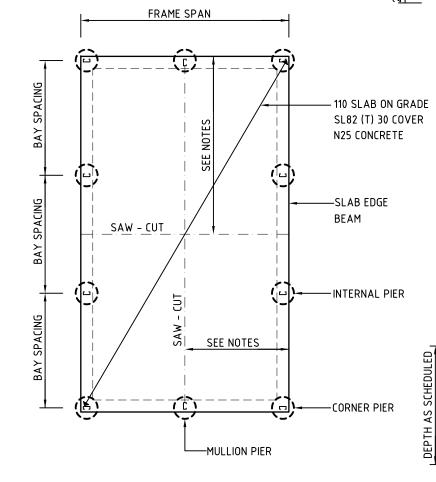

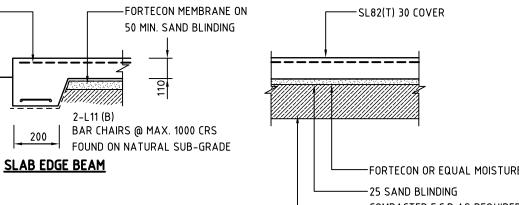

UNDER SLAB PREP

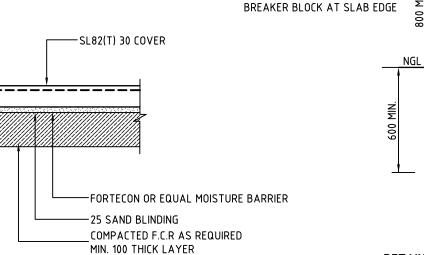

-20d x 10w SAW-CUT JOINT

FORMED WITHIN 3 DAYS OF

CASTING SLAB

PLACE SAW CUTS AT NO MORE THAN 6m INTERVALS

SLAB SAW-CUT DETAIL

WHERE SLAB O/A LENGTH > 9.0m

RETAINING WALL DETAILS

450

HEIGHT > 500mm HEIGHT < 1000mm

2

COMPACTED GRANULAR FILL COMPACT IN 200 MAX LAYERS

BOGAR SPACERS AT 900 CRS


WITH VIBRATING ROLLER

STRIP FOOTING WITH

4-L11 (T) & (B)

AS REQUIRED

-APPROVED BASE

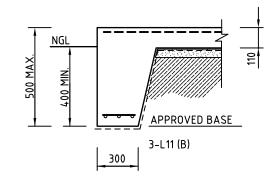

RETAINING WALL DETAILS

HEIGHT < 500mm

TYPICAL SLAB & PIER LAYOUT

(<u>-</u>)

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SLAB DESIGN FOR CLASS A,S & M TO AS 2870 TYPICALLY N25 CONCRETE 30mm COVER TO REO LAP REO MIN. 225mm SUPPORT ON BAR CHAIRS AT 1000 MAX crs POUR PIER FOOTINGS INTEGRAL WITH SLAB, DO NOT PLACE INFILL CONCRETE SLAB AGAINST WALL SHEETING PROVIDE 25mm POLYSTYRENE SHEET AS BARRIER

PIER/SLAB DETAIL

450 Ø

NGL

NOTE: REFER RAINBOW BUILDING SOLUTIONS SPECIFICATIONS FOR SITE SPECIFIC INFORMATION & STRUCTURAL CERTIFICATION



190 BLOCKWORK

N12-600crs VERT & HORIZ

300 LAPS 1000 MAX HEIGHT



- NATURAL SUB-GRADE

CONSULTING ENGINEERS Emmanuel Dellas Pty Ltd RAINBOW BUILDING SOLUTIONS STEEL FRAMED BUILDINGS, 7.5m MAX SKILLION SHED CONSTRUCTION FOOTING/SLAB DETAILS - CLASS 10A STRUCTURES ONLY

Job No. **RAINB - 7.5**

Drawing No.


Scale:

N.T.S

phone: 6228 2225 fax: 6228 2235 mobile: 0418 232 811 email: edellas@bigpond.com GPO Box 1805 Hobart 7001

ED Accreditation Number:

CC164C June '19

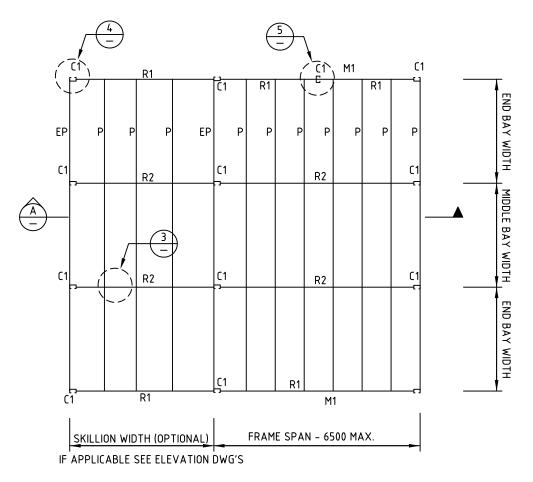

ROOF FRAMING PLAN




ROOF & WALL SHEETING MAX. SPAN TABLES						
CLADDING	LOCATION	END SPAN	INT SPAN			
CORRUGATED 0.42 BMT	ROOF	900	1200			
CORRUGATED 0.42 BMT	WALL	1200	1500			
K-PANEL 0.42 BMT	WALL	1200	1500			
MONOCLAD 0.42 BMT	ROOF	900	1200			
MONOCLAD 0.42 BMT	WALL	1200	1500			

RBS CONSTRUCTION NOTES:

NOTES:

- 1. REFER RAINBOW BUILDING SPECIFICATIONS FOR SITE SPECIFIC INFORMATION
- 2. END WALL CLADDING CAN BE DELETED TO ENABLE OPEN END BAYS
- 3. WALL CLADDING CAN BE DELETED ONE FULL SIDE PROVIDE MIN. 1 BRACED BAY EACH SIDE
- 4. WHERE 2 OR MORE BAYS OPEN SIDED & COLUMNS > 3.0m IN HEIGHT PROVIDE BACK TO BACK COLUMNS

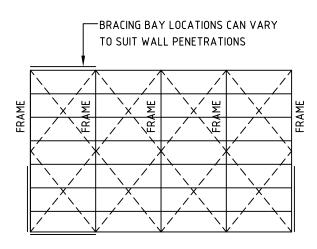


ROOF & WALL BRACING

139 Main Road Sorell, TAS 7172

ALL BRACING 32 X 1.2 G500 GI STRAP 2 – 14g X 22 TEK SCREWS EACH END TO FRAMES WITH TENSIONER FIX TO EXTERNAL FACE OF COLUMNS & RAFTERS

NOTE: REFER RAINBOW BUILDING SOLUTIONS SPECIFICATIONS FOR SITE SPECIFIC INFORMATION & STRUCTURAL CERTIFICATION

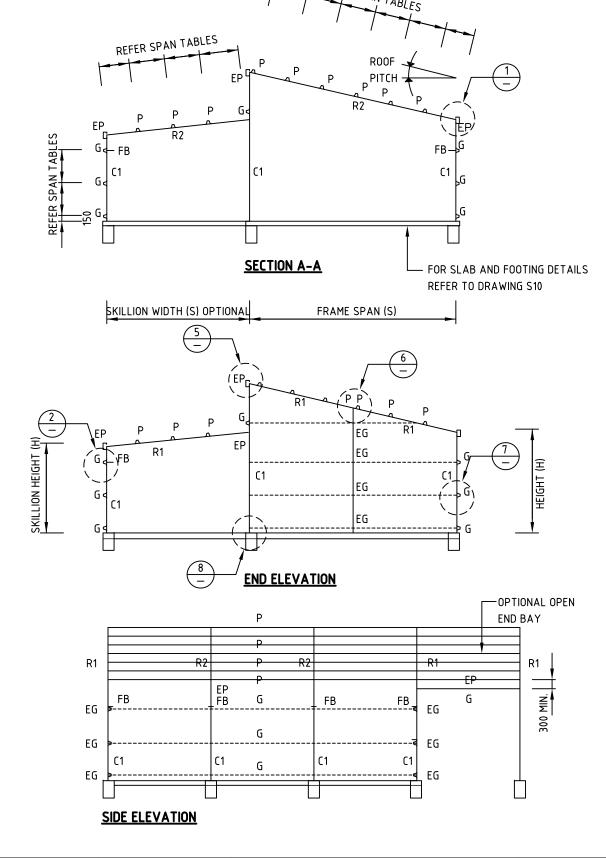



building solutions

T: 1300 737 910

CONSULTING ENGINEERS Emmanuel Dellas Pty Ltd

phone: 6228 2225 fax: 6228 2235 mobile: 0418 232 811

email: edellas@bigpond.com GPO Box 1805 Hobart 7001 RAINBOW BUILDING SOLUTIONS
STEEL FRAMED BUILDINGS, 7.5m MAX
SKILLION SHED CONSTRUCTION
TYPICAL WALL FRAMING &
ROOF FRAMING DETAILS

Job No. RAINB - 7.5

Scale:

N.T.S


ED Accreditation Number: Date:
. CC164C June '


Drawing No.


S11

June '15

www.rainbowbuilding.com.au T: 1300

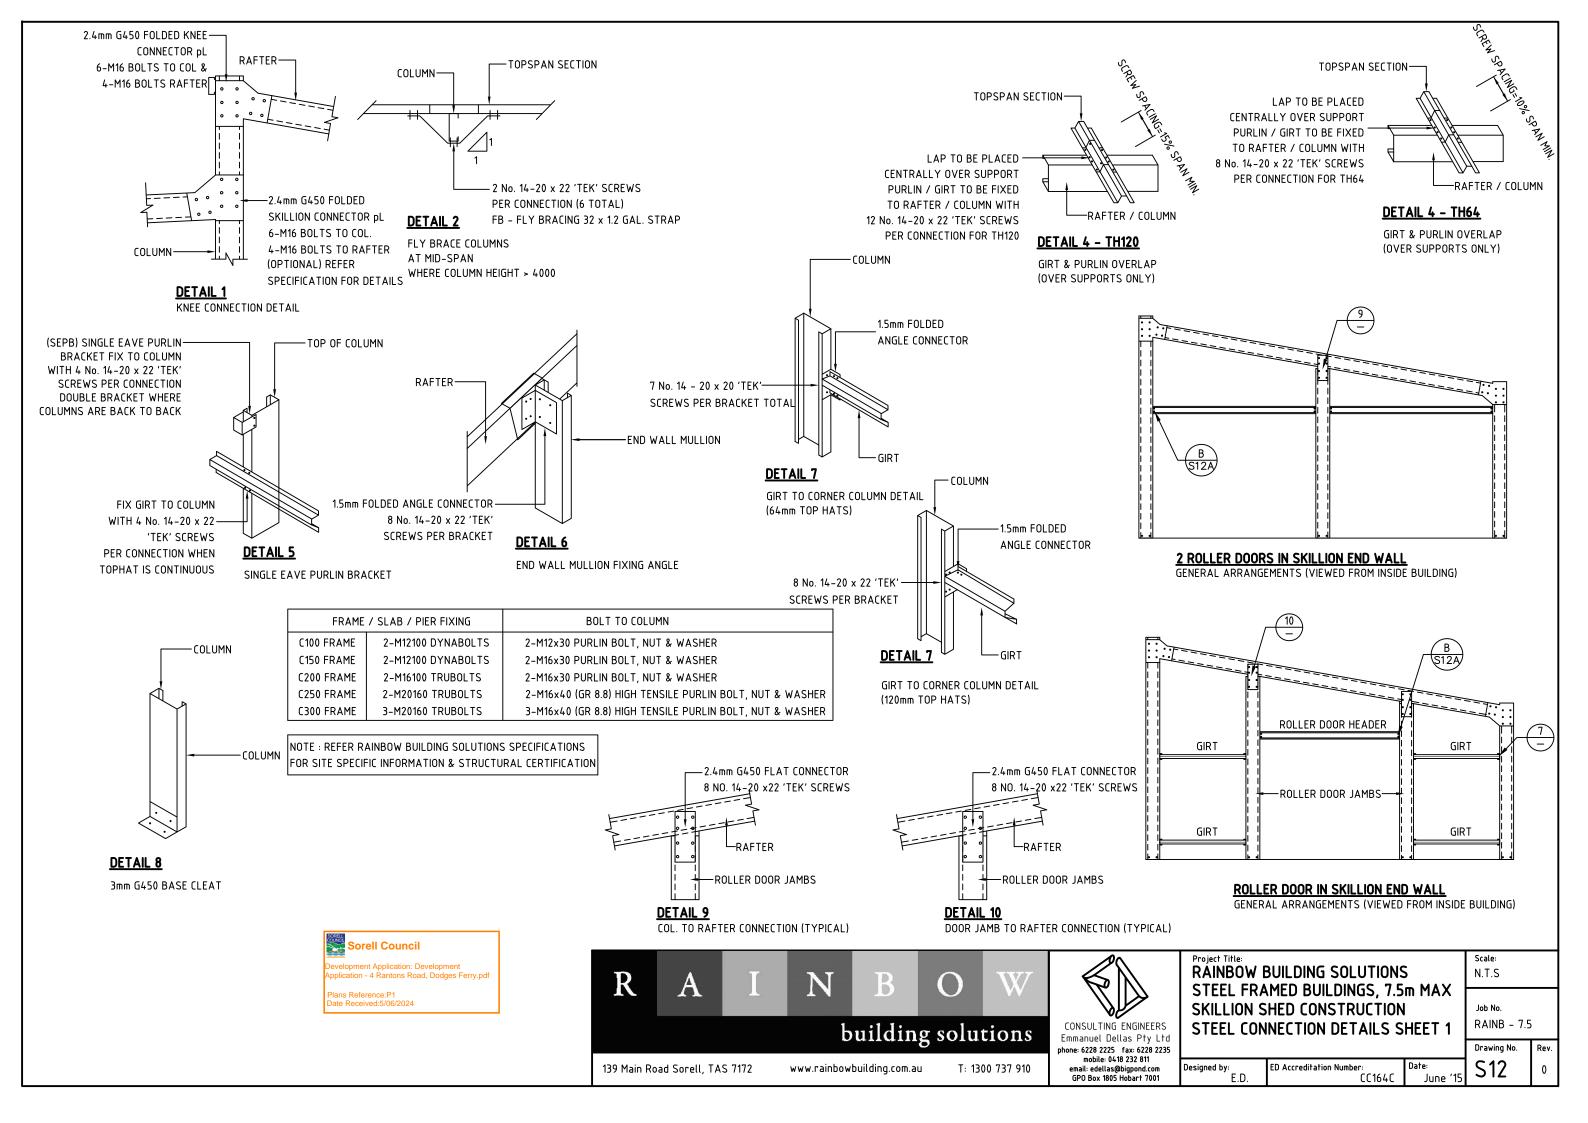

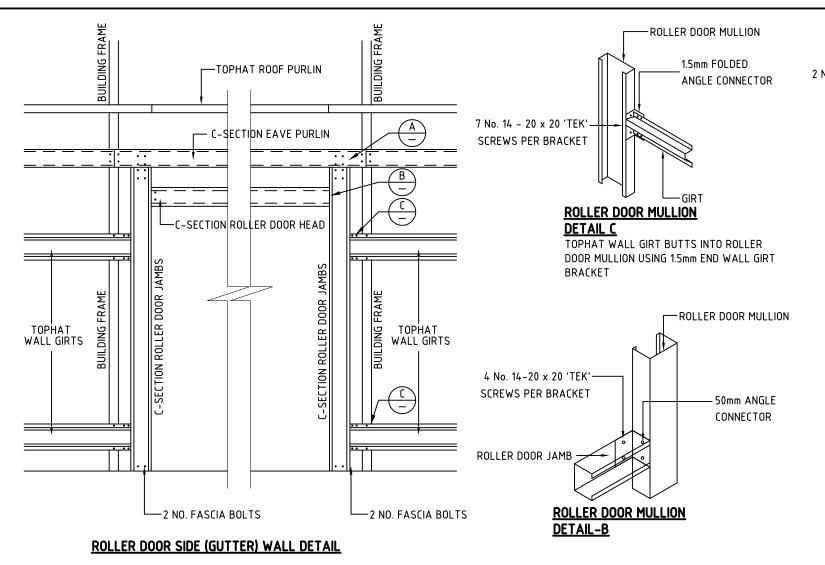

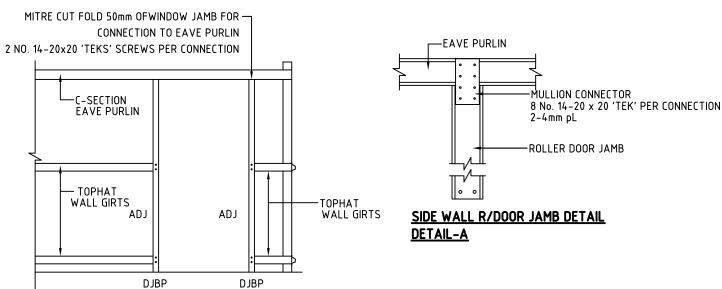

PERSONAL ACCESS DOOR DETAIL

ACCESS DOOR KIT COMPRISES 2 NO. ACCESS DOOR JAMBS (ADJ) BASE PLATE DJBP 2 NO. M12 x 70 DYNABOLTS 2 NO. 50mm ANGLE CONNECTORS 32 NO. 14-20x20 'TEKS' SCREWS 2 NO. DYNABOLTS PER PA DOOR HEX HEAD -(Z) 1 NO. ACCESS DOOR AND DOOR HARDWARE

C2

Sorell Council elopment Application: Development cation - 4 Rantons Road, Dodges Ferry.pdf

DOOR HEAD FLASHING - 50x50 CORNER

ROLLER DOOR KIT COMPRISES

C150 ROLLER DOOR JAMBS

2 NO. M16x30 FASCIA BOLTS

2 NO. M12x100 DYNA BOLTS

C100 ROLLER DOOR JAMBS

2 NO. M12x30 FASCIA BOLTS 2 NO. M12x100 DYNA BOLTS


WINDOW FRAME KIT COMPRISES

2 NO. WINDOW JAMBS (WJ)

24 NO. 14-20x20 'TEKS' SCREWS


1 NO. WINDOW & WINDOW HARDWARE

NOTE: REFER RAINBOW BUILDING SOLUTIONS SPECIFICATIONS FOR SITE SPECIFIC INFORMATION & STRUCTURAL CERTIFICATION

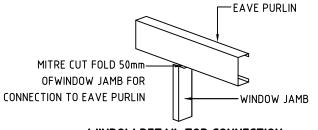


WINDOW DETAIL TOP CONNECTION DETAIL-E

ALL CONNECTIONS TO BE 'TEKS' SCREWED USING 2 NO. 14-20x20 'TEKS' SCREWS PER CONNECTION

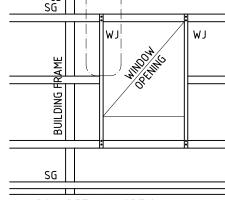

WINDOW DETAIL - OPTION 1

4 NO. 14-20x20 'TEKS' SCREWS PER CONNECTION 4 NO. 14-20x20 'TEKS' SCREWS PER CONNECTION

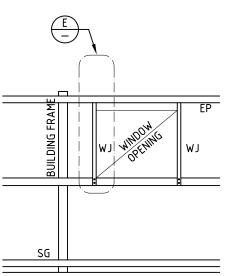


WINDOW DETAIL - OPTION 2 ALL CONNECTIONS TO BE 'TEKS' SCREWED USING ALL CONNECTIONS TO BE 'TEKS' SCREWED USING

WINDOW JAMB

WINDOW DETAIL BOTTOM CONNECTION **DETAIL-D & E**

ALL CONNECTIONS TO BE 'TEKS' SCREWED USING 2 NO. 14-20x20 'TEKS' SCREWS PER CONNECTION

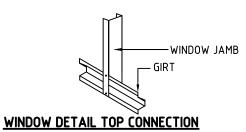

DETAIL-D ALL CONNECTIONS TO BE 'TEKS' SCREWED USING

2 NO. 14-20x20 'TEKS' SCREWS PER CONNECTION

building solutions

CONSULTING ENGINEERS Emmanuel Dellas Pty Ltd phone: 6228 2225 fax: 6228 2235

RAINBOW BUILDING SOLUTIONS STEEL FRAMED STRUCTURES 7.5 MAX SKILLION SHED CONSTRUCTION STEEL CONNECTION DETAILS SHEET 2

Job No. **RAINB - 7.5**

N.T.S

Drawing No. **S12A**

www.rainbowbuilding.com.au 139 Main Road Sorell, TAS 7172


T: 1300 737 910

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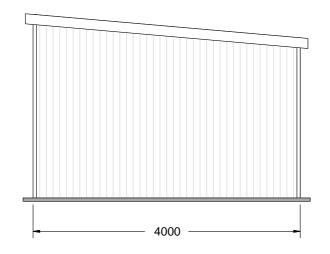
email: edellas@bigpond.com GPO Box 1805 Hobart 7001

Designed by: E.D.

ED Accreditation Number:

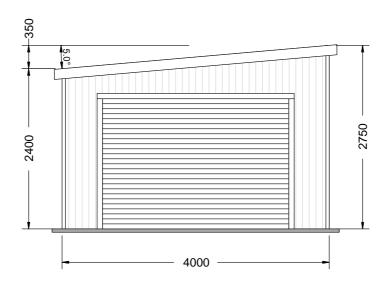

FRONT ELEVATION





evelopment Application: Development Application - 4 Rantons Road, Dodges Ferry.pdf

Plans Reference:P1 Date Received:5/06/2024





139 Main Road, Sorell TAS 7172 Phone: 1300 737 910

Email: sales@rainbowbuilding.com.au

CLIENT: Robert McLeod

DRAWING TITLE: End Elevations

SITE ADDRESS: 4 Rantons Road, DODGES FERRY, TAS, 7173 SCALE: 1:56.630


PHONE:

DATE: 04-09-2023

EMAIL: robbiemc_1983@hotmail.com

Job Number: SOR03_610

Drawing Number: EE

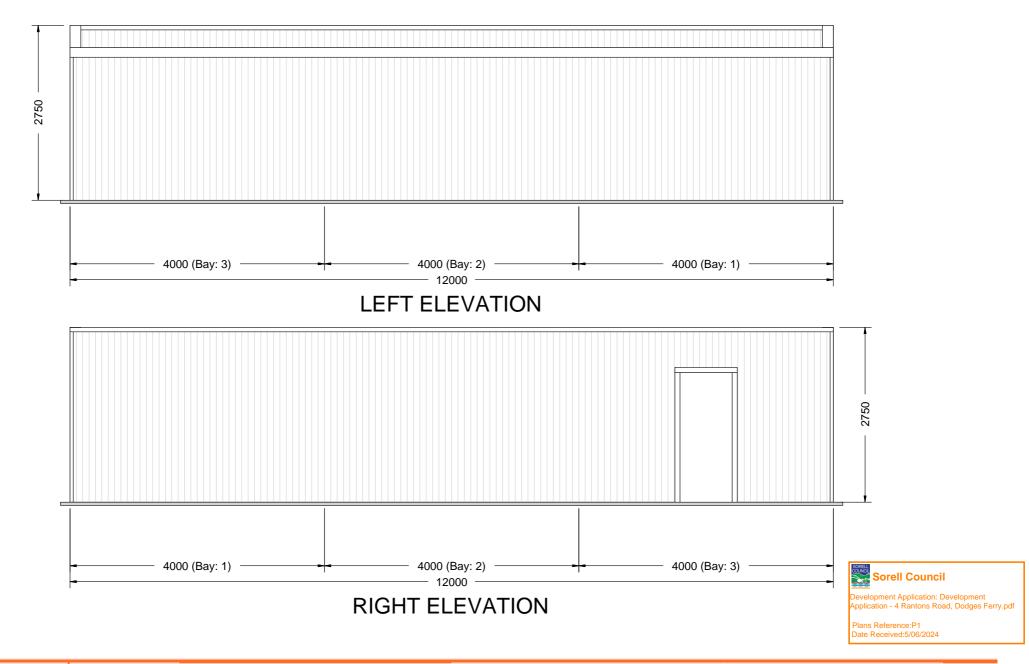



139 Main Road. Sorell TAS 7172 Phone: 1300 737 910 Email: sales@rainbowbuilding.com.au

CLIENT: Robert McLeod


DRAWING TITLE: Side Elevations

SITE ADDRESS: 4 Rantons Road, DODGES FERRY, TAS, 7173 SCALE: 1:59.466

PHONE: EMAIL: robbiemc_1983@hotmail.com

DATE: 04-09-2023 Job Number: SOR03_610

Drawing Number: SE

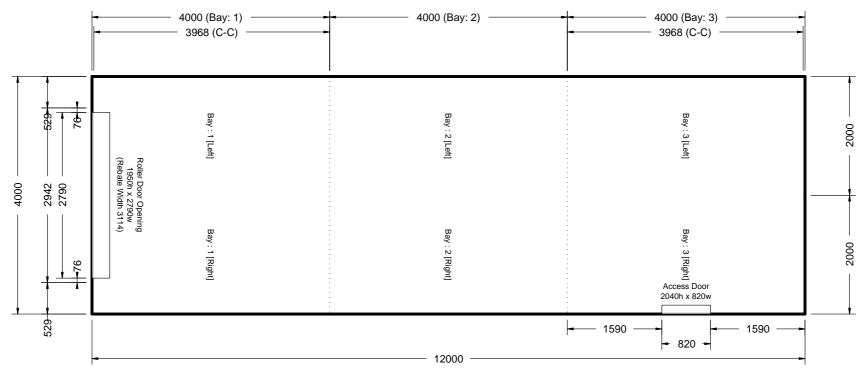

PLAN ELEVATION



evelopment Application: Development Application - 4 Rantons Road, Dodges Ferry.pdf

Plans Reference:P1 Date Received:5/06/2024



139 Main Road, Sorell TAS 7172 Phone: 1300 737 910

Email: sales@rainbowbuilding.com.au


CLIENT: Robert McLeod

DRAWING TITLE: Plan Elevation


SITE ADDRESS: 4 Rantons Road, DODGES FERRY, TAS, 7173 SCALE: 1:63.654

PHONE: DATE: 04-09-2023 EMAIL: robbiemc_1983@hotmail.com Job Number: SOR03_610

Drawing Number: FPE

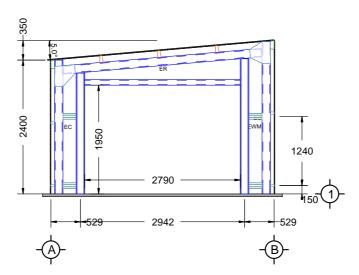

FRONT ELEVATION

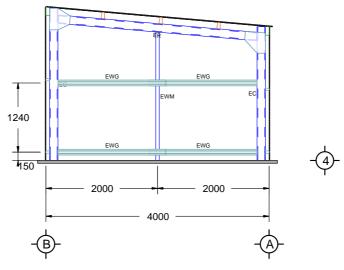







139 Main Road, Sorell TAS 7172 Phone: 1300 737 910

Email: sales@rainbowbuilding.com.au


CLIENT: Robert McLeod

DRAWING TITLE: End Frame Elevations


SITE ADDRESS: 4 Rantons Road, DODGES FERRY, TAS, 7173 SCALE: 1:67.797

PHONE: DATE: 04-09-2023
EMAIL: robbiemc_1983@hotmail.com Job Number: SOR03_610

Drawing Number: EFE

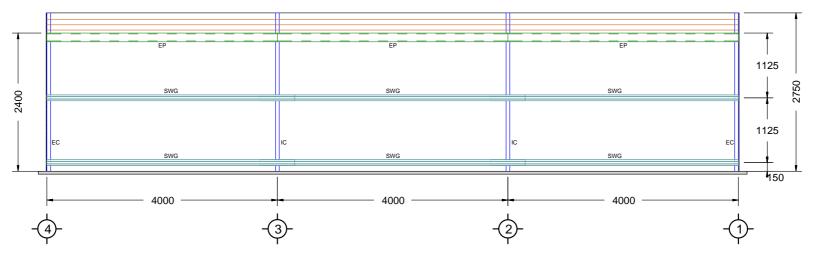

LEFT ELEVATION

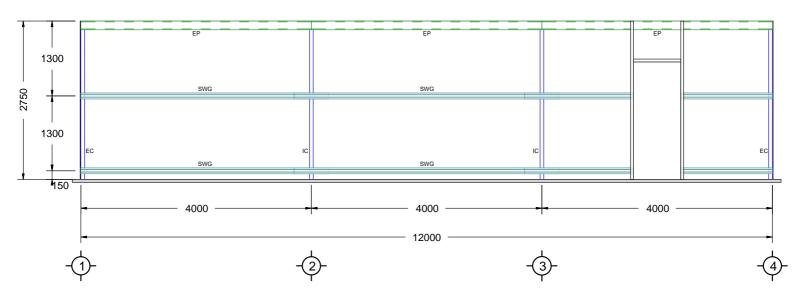



Development Application: Development Application - 4 Rantons Road, Dodges Ferry.pdf

Plans Reference:P1 Date Received:5/06/2024

RIGHT ELEVATION

139 Main Road, Sorell TAS 7172 Phone: 1300 737 910

Email: sales@rainbowbuilding.com.au

CLIENT: Robert McLeod

DRAWING TITLE: Side Frame Elevations

SITE ADDRESS: 4 Rantons Road, DODGES FERRY, TAS, 7173 SCALE: 1:65.633


PHONE: DATE: 04-09-20:

DATE: 04-09-2023 Job Number: SOR03_610

EMAIL: robbiemc_1983@hotmail.com

Drawing Number: SFE



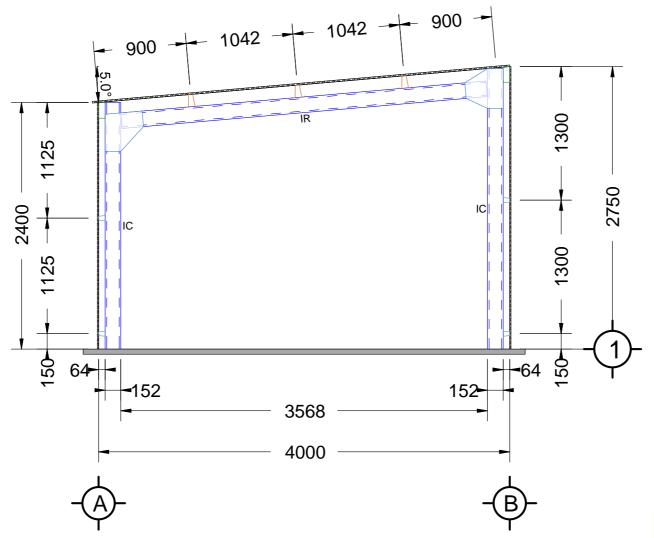

INTERMEDIATE ELEVATION



Development Application: Development Application - 4 Rantons Road, Dodges Ferry.pdf

Plans Reference:P1 Date Received:5/06/2024

139 Main Road, Sorell TAS 7172 Phone: 1300 737 910

Email: sales@rainbowbuilding.com.au

CLIENT: Robert McLeod

PHONE:

DRAWING TITLE: Cross Section

SITE ADDRESS: 4 Rantons Road, DODGES FERRY, TAS, 7173 SCALE: 1:36.795


DATE: 04-09-2023

EMAIL: robbiemc_1983@hotmail.com

DATE: 04-09-2023 Job Number: SOR03_610

Drawing Number: CS



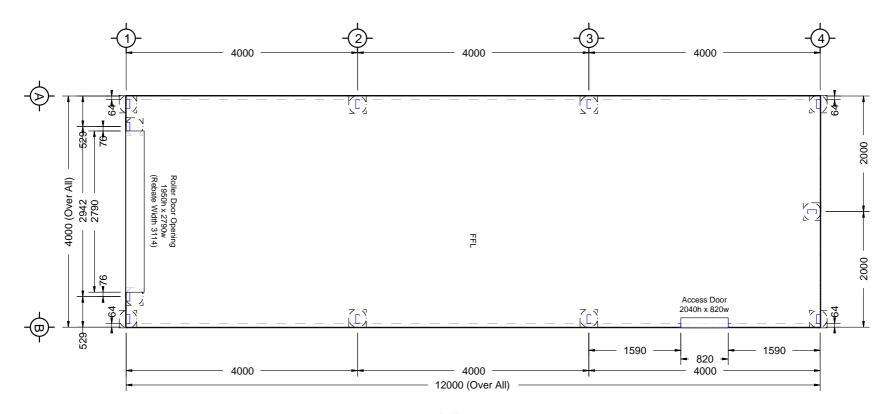

FLOOR PLAN



139 Main Road, Sorell TAS 7172 Phone: 1300 737 910

Email: sales@rainbowbuilding.com.au

CLIENT: Robert McLeod

DRAWING TITLE: Floor Plan

PHONE:

SITE ADDRESS: 4 Rantons Road, DODGES FERRY, TAS, 7173 SCALE: 1:65.401 DATE: 04-09-2023 Job Number: SOR03_610

EMAIL: robbiemc_1983@hotmail.com

Drawing Number: FP







